BUSINESS

# USC SCHOOL OF MEDICINE 15 MED PARK BATHROOM RENOVATION

1ST FLOOR: EXISTING FIXTURE COUNTS TO REMAIN.

3RD FLOOR: EXISTING FIXTURE COUNTS TO REMAIN.

3555 HARDEN STREET EXT. COLUMBIA, SC, 29201

# **BUILDING CODE SUMMARY**


PROJECT INFORMA	ATION					]	NOTE	E: CODE INFORMATION FOR	AREA OF RENOVATION ONLY.	PLUMBING FIXTURE REQUIREMENTS
NAME OF PROJECT:		USC 15 MED PARK BATHROOM RENOVATION								BASEMENT:
ADDRESS:		•	RDEN STREET E	XT COLU	MBIA, SC 2	9201				1ST FLOOR: EXISTING FIXTURE COUNTS TO REMA
PROPOSED USE: OWNER OR AUTHORIZED	AGENT:	EXISTING BATHROOMS  UNIVERSIY OF SOUTH CAROLINA								2ND FLOOR:
OWNED BY:	AGEITT.	PRIVATE			3RD FLOOR: EXISTING FIXTURE COUNTS TO REM					
CODE ENFORCEMENT JUR	RISDICTION	M: CITY OF	COLUMBIA							
PROJECT DESIGN 1	ГЕАМ									
DESIGNER	FIRM				CONTACT			PHONE #		
ARCHITECTURAL:		2LR, INC.			GRETCHEN	LAMBERT		(803) 233-6602	2	
CIVIL:								()	-	
STRUCTURAL: PLUMBING:	 CMVCEDT	AND ACCOCT	ATES, LTD.		TODD SWYG	דסקי		(803) 791-9300		
FIRE PROTECTION:		AND ASSOCI	AIES, LID.			JENI		()		
MECHANICAL:	SWYGERT	AND ASSOCI	ATES, LTD.		BILL LIVI	NGSTON		(803) 791-9300	0	
SPRINKLER-STANDPIPE: ELECTRICAL:	I.AND EN	GINEERING A	ASSOCIATES, L	I.C	JOE LAND			() (803) 528-143°		
OTHER:		GINEENING A	ADDOCIATED, E	<u> </u>				()		
CODE COMPLIANCI	E									
INTERNATIONAL BUILDING			<del></del>		WITH SC MOI	DIFICATIONS				
INTERNATIONAL PLUMBIN INTERNATIONAL MECHAN		<u>:</u> :	2012 ED						_	
INTERNATIONAL FIRE COL			2012 WI	TH SC 1	MODIFICATIO	ONS				
NATIONAL ELECTRIC COD INTERNATIONAL ENERGY			2011 ED 2009 ED							
ICC/ANSI - 117.1:	CONSLAV	ATION CODE	2009 ED							
ADA STANDARDS FOR AC	CESSIBLE	DESIGN	_2010 ED	ITION						
									•	
BUILDING DATA										
CONSTRUCTION TYPE (TA	ABLE 503):		SUMED, UNKNOW	N						
SPRINKLERS: STANDPIPES:		NO NO								
FIRE DISTRICT:		N/A								
BUILDING HEIGHT: MEZZANINE:		NO EXI	ST FEET		4	NUMBE	R OF	STORIES UNLIMIT	TED PER	
HIGH RISE:		NO								
GROSS BUILDING AREA:										
FLOOR		EXISTING	i (SQ. FT.)		NE\	W (SQ. FT.)		SUB-TOTA	AL	
BASEMENT		XXX						1XXX		
1ST FLOOR		XXX						1XXX		
2ND FLOOR		XXX						1XXX		
3RD FLOOR		XXX						1XXX		
TOTAL								XXX		
ALLOWABLE AREA										
PRIMARY OCCUPANCY:		GROUP B		F	LOOR AREA	PER OCCUPANT	Т (ТА	ABLE 1004.1.2): 100 SF GRO	OSS PER PERSON	
SECONDARY OCCUPANCY SPECIAL OCCUPANCY:	Y:	<del></del>					•	,		
MIXED OCCUPANCY:		NO				HR.				
NON-SEPARATED	MIXED OC	CUPANCY (30	)2.3.1) THE REC	UIRED	TYPE OF CO	NSTRUCTION FO	OR TI	HE BUILDING SHALL BE DET	ERMINED BY APPLYING	
THE HEIGHT AND CONSTRUCTION,	AREA LIMIT	TATIONS FOR	REACH OF THE	<b>APPLIC</b>	ABLE OCCUI	PANCIES FOR TH	HE E	NTIRE BUILDING. THE MOST	RESTRICTIVE TYPE OF	
SEPARATED MIXE	D OCCUPA	NCY (302.3.2	) SEE BELOW F	OR ARE	A CALCULAT			RY, THE AREA OF THE OCCU		
THAT THE SUM OF EXCEED 1.	F THE RATI	OS FOR THE	ACTUAL FLOOI	RAREA	OF EACH US	E DIVIDED BY TI	HE A	ALLOWABLE FLOOR AREA FO	OR EACH USE SHALL NOT	
FIRE PROTECTION										
LIFE SAFETY SHEET #, IF	PROVIDED	: <u>N/A</u>								
EXIT REQUIREMENT NUMBER AND ARR		ENTS OF I	EXITS							
FLOOR, ROOM OR SPAC DESIGNATION	E	MINIMUM NI EXITS <sup>2</sup>	UMBER OF	TRAVE	EL DISTANCE			ARRANGEMENTS MEANS ( (SECTION 1015.2) 1,3	OF EGRESS	
DESIGNATION		REQ'D	SHOWN	ALLOV	VARI E	ACTUAL		REQUIRED DISTANCE	ACTUAL DISTANCE	
		TIL QI D	ON PLANS	TRAVE	EL	TRAVEL		BETWEEN EXIT DOORS	SHOWN ON PLANS	
				DISTA (TABLI	NCE E 1016.2)	DISTANCE SHOWN ON				
						PLANS				
BUSINESS		Х	Х	300'		<300'		X'-X"	X'-X"	
EXIT WIDTH										
USE GROUP OR SPACE		(A)	(B)		(C)		EX	(IT WIDTH (INCHES) 2,3,4,5,6		
DESCRIPTION		AREA	AREA PER		EGRESS W	/INTU DED	חר	EQUIRED WIDTH	ACTUAL WIDTH SHOWN	
		(SQ. FT.)	OCCUPAN	Т	OCCUPAN	T (TABLE	KE	-WOIDEN MINIU	ON PLANS	
			(TABLE 100	J4.1.2)	1005.3.1 Al	ND 1005.3.2)				
			ĺ				1			

SHEET NO.	Sheet Name
AD201	DEMOLITION RCP
GENERAL	
CVR	COVER SHEET AND BUILDING CODE SUMMARY
ARCHITECTUR!	AL DEMOLITION
AD101	DEMOLITION FLOOR PLANS
AD102	DEMOLITION FLOOR PLANS
ARCHITECTUR!	AL
A101	FLOOR PLANS
A102	FLOOR PLANS & TYP TOILET DETAILS
A201	REFLECTED CEILING PLANS BASE BID
A202	REFLECTED CEILING PLANS ALTERNATE 1
A401	ELEVATIONS
A801	DOOR SCHEDULE
A901	FINISH SCHEDULE
MECHANICAL D	EMOLITION
MD101	DEMOLITION FLOOR PLANS - ALTERNATE 1
MECHANICAL	
M101	RENOVATION FLOOR PLANS - ALTERNATE 1
M201	DETAILS, NOTES, SCHEDULES AND LEGEND
PLUMBING DEM	IOLITION
PD101	DEMOLITION FLOOR PLANS
PLUMBING	
P101	RENOVATION FLOOR PLANS
P201	DETAILS, NOTES, SCHEDULES AND LEGEND
ELECTRICAL	
E100	GENERAL NOTES, LEGEND, AND SCHEDULE
E101	FIRST FLOOR ELECTRICAL PLANS
E102	SECOND FLOOR ELECTRICAL PLANS
E103	THIRD FLOOR ELECTRICAL PLANS


**DRAWING LIST** 




WOOD

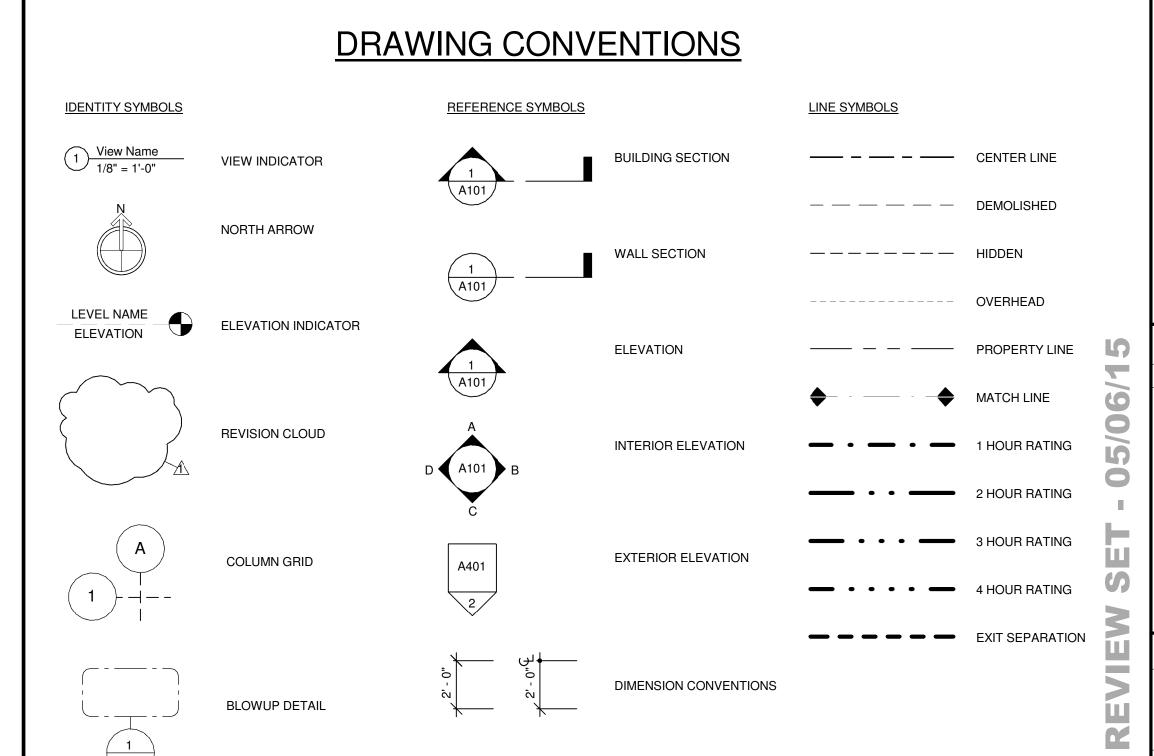

SLOPE CONVENTION

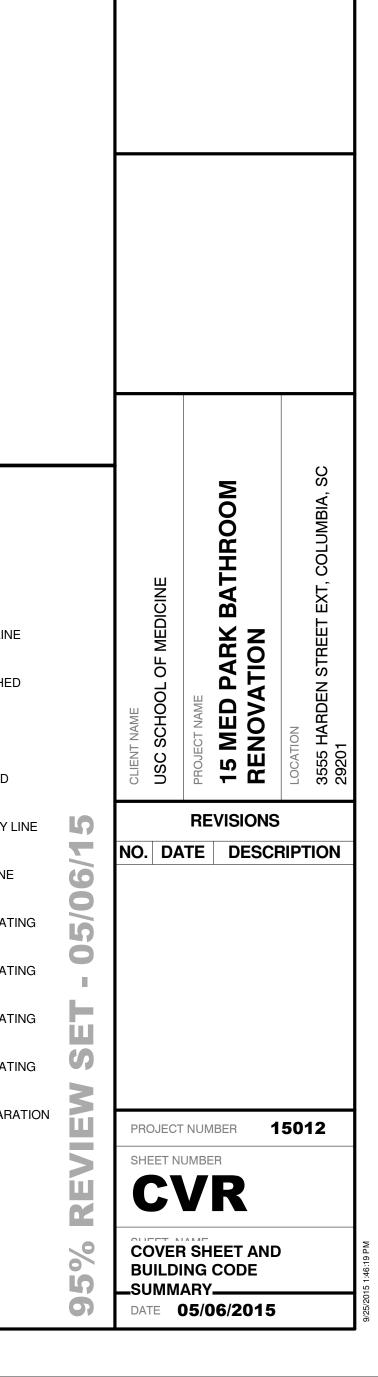

ARCHITE

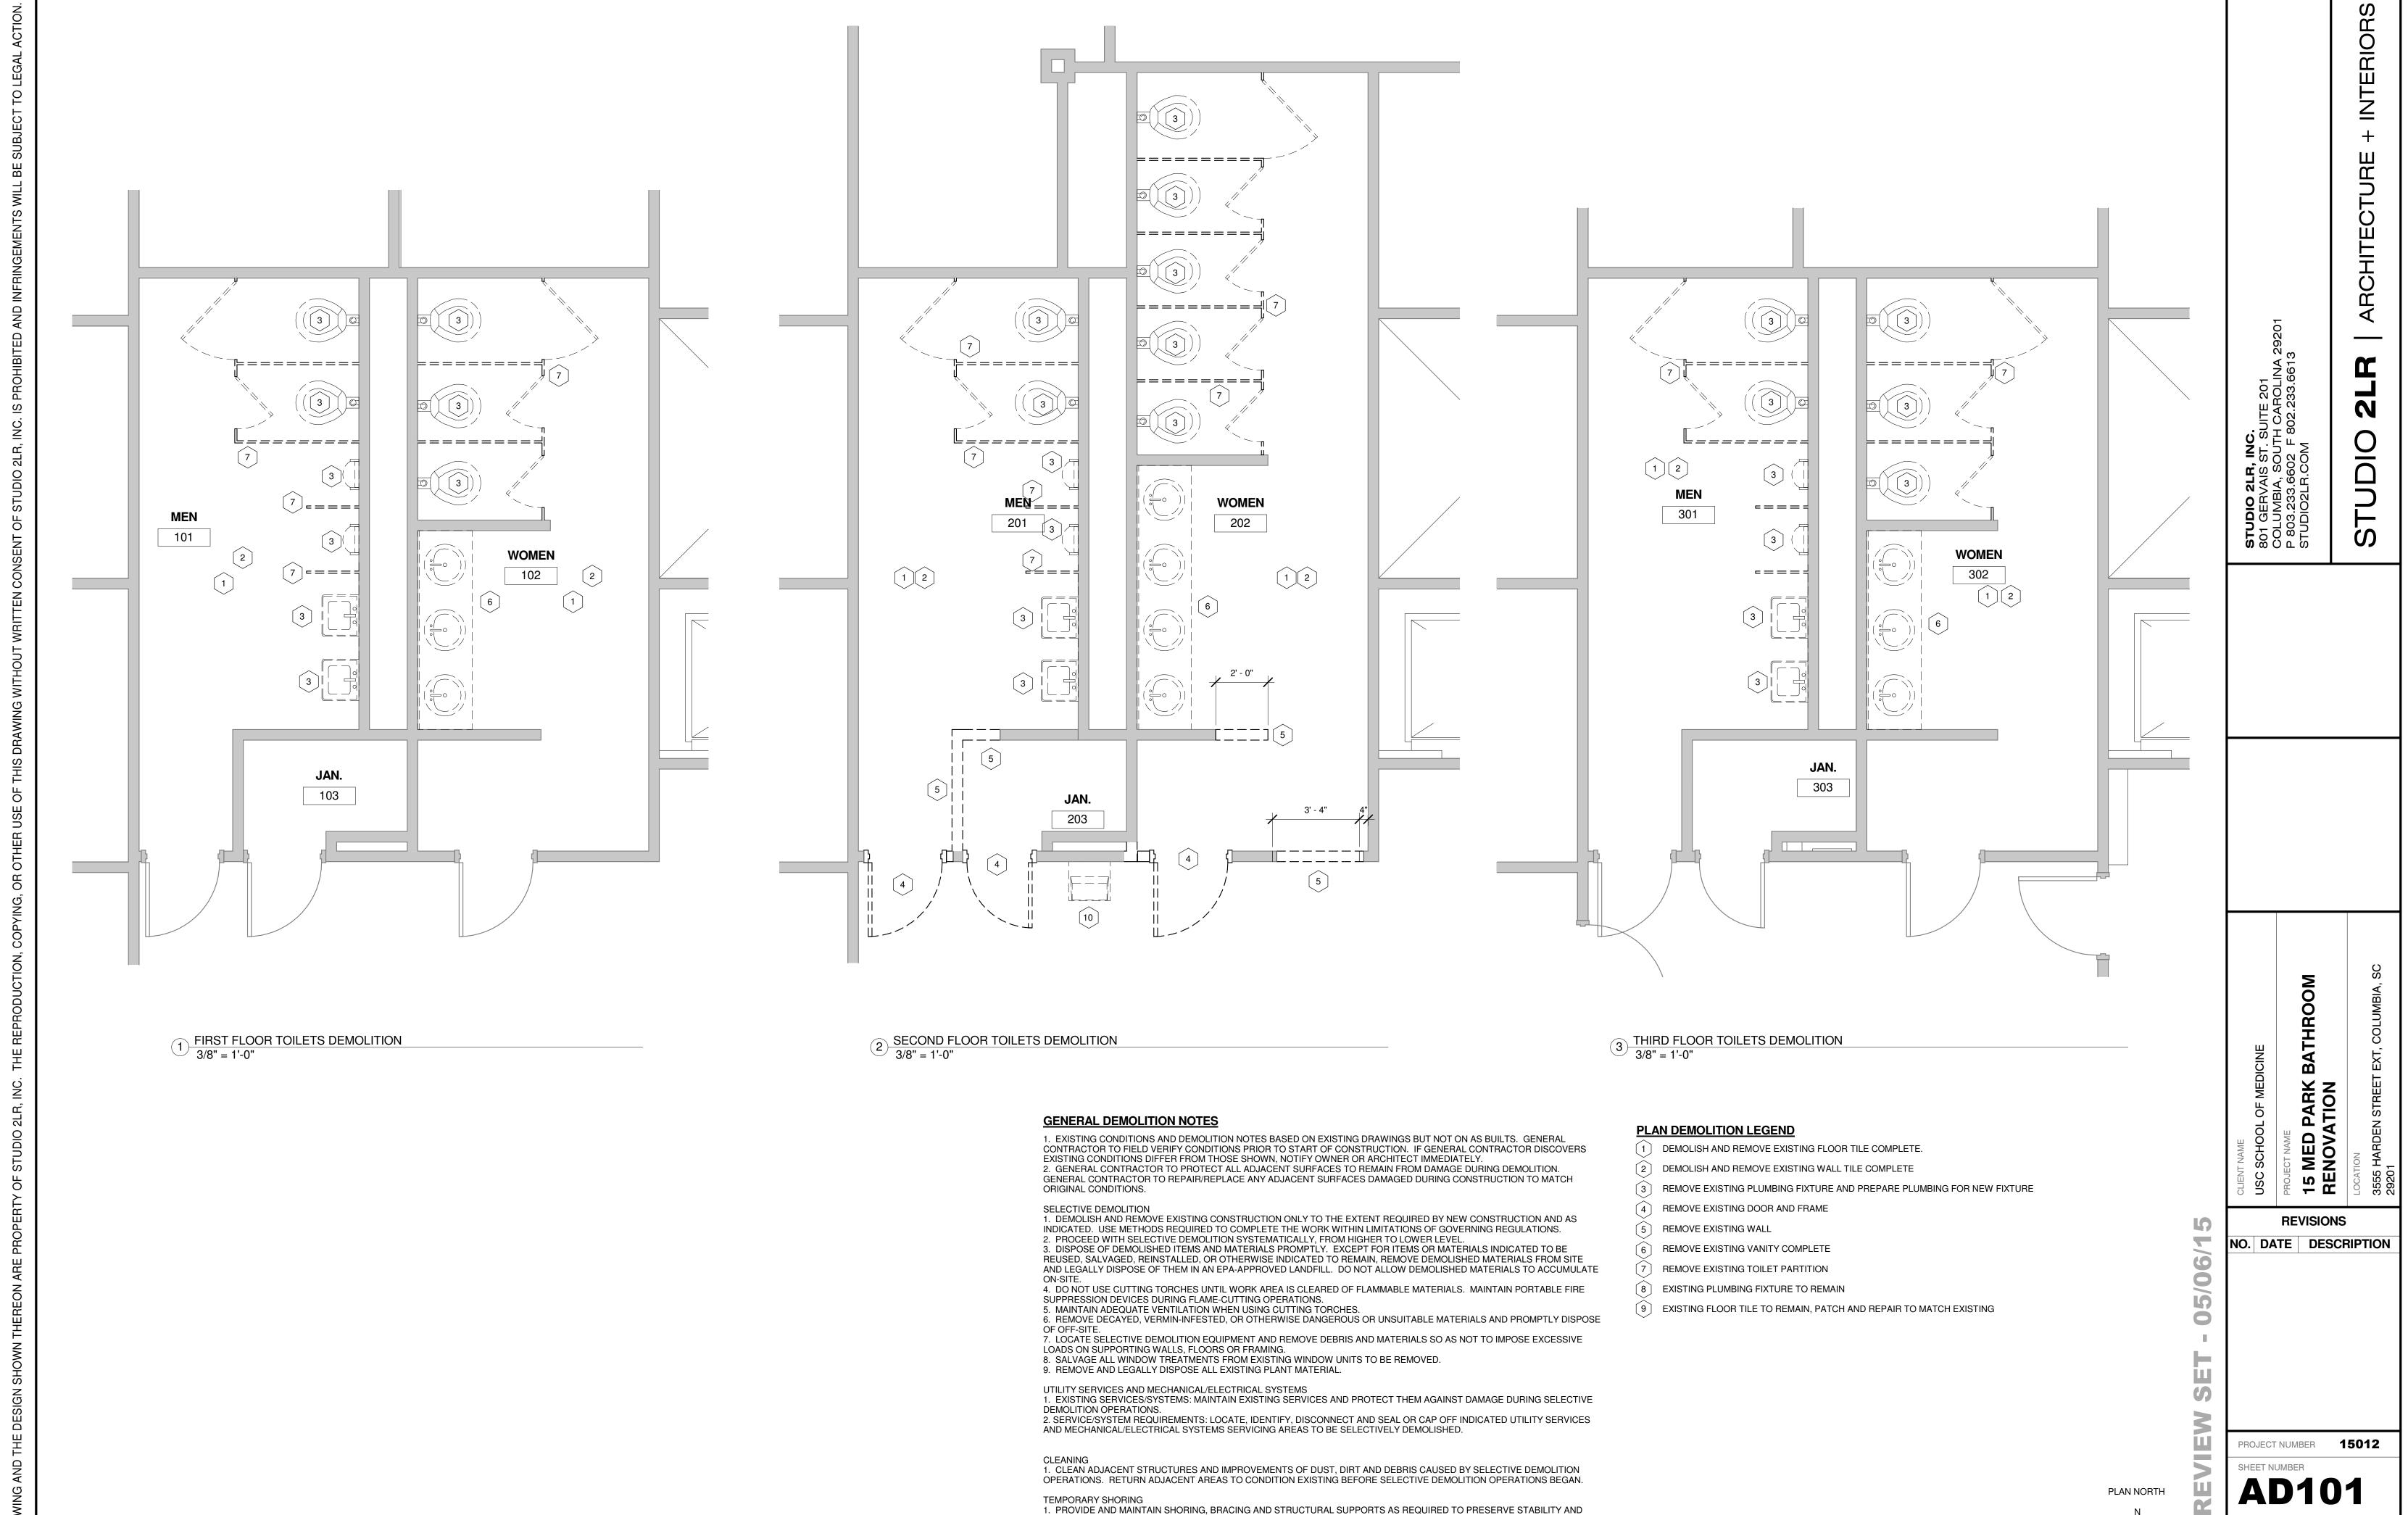

PREVENT MOVEMENT, SETTLEMENT, OR COLLAPSE OF CONSTRUCTION AND FINISHES TO REMAIN, AND TO PREVENT

NEW SUPPORTS WHEN REQUIRED DURING PROGRESS OF SELECTIVE DEMOLITION.

UNEXPECTED OR UNCONTROLLED MOVEMENT OR COLLAPSE OF CONSTRUCTION BEING DEMOLISHED. STRENGTHEN OR ADD

**DEMOLITION FLOOR** 

**PLANS** 

# **GENERAL DEMOLITION NOTES**

1. EXISTING CONDITIONS AND DEMOLITION NOTES BASED ON EXISTING DRAWINGS BUT NOT ON AS BUILTS. GENERAL CONTRACTOR TO FIELD VERIFY CONDITIONS PRIOR TO START OF CONSTRUCTION. IF GENERAL CONTRACTOR DISCOVERS EXISTING CONDITIONS DIFFER FROM THOSE SHOWN, NOTIFY OWNER OR ARCHITECT IMMEDIATELY.
2. GENERAL CONTRACTOR TO PROTECT ALL ADJACENT SURFACES TO REMAIN FROM DAMAGE DURING DEMOLITION. GENERAL CONTRACTOR TO REPAIR/REPLACE ANY ADJACENT SURFACES DAMAGED DURING CONSTRUCTION TO MATCH ORIGINAL CONDITIONS.

ELECTIVE DEMOLITION

1. DEMOLISH AND REMOVE EXISTING CONSTRUCTION ONLY TO THE EXTENT REQUIRED BY NEW CONSTRUCTION AND AS INDICATED. USE METHODS REQUIRED TO COMPLETE THE WORK WITHIN LIMITATIONS OF GOVERNING

REGULATIONS.

2. PROCEED WITH SELECTIVE DEMOLITION SYSTEMATICALLY, FROM HIGHER TO LOWER LEVEL.
3. DISPOSE OF DEMOLISHED ITEMS AND MATERIALS PROMPTLY. EXCEPT FOR ITEMS OR MATERIALS INDICATED TO BE REUSED, SALVAGED, REINSTALLED, OR OTHERWISE INDICATED TO REMAIN, REMOVE DEMOLISHED MATERIALS FROM SITE AND LEGALLY DISPOSE OF THEM IN AN EPA-APPROVED LANDFILL. DO NOT ALLOW DEMOLISHED MATERIALS TO ACCUMULATE ON-SITE.

4. DO NOT USE CUTTING TORCHES UNTIL WORK AREA IS CLEARED OF FLAMMABLE MATERIALS. MAINTAIN PORTABLE FIRE SUPPRESSION DEVICES DURING FLAME-CUTTING OPERATIONS.

6. REMOVE DECAYED, VERMIN-INFESTED, OR OTHERWISE DANGEROUS OR UNSUITABLE MATERIALS AND PROMPTLY DISPOSE OF OFF-SITE.

7. LOCATE SELECTIVE DEMOLITION EQUIPMENT AND REMOVE DEBRIS AND MATERIALS SO AS NOT TO IMPOSE EXCESSIVE LOADS ON SUPPORTING WALLS, FLOORS OR FRAMING.

8. SALVAGE ALL WINDOW TREATMENTS FROM EXISTING WINDOW UNITS TO BE REMOVED.

9. REMOVE AND LEGALLY DISPOSE ALL EXISTING PLANT MATERIAL.

5. MAINTAIN ADEQUATE VENTILATION WHEN USING CUTTING TORCHES.

UTILITY SERVICES AND MECHANICAL/ELECTRICAL SYSTEMS

1. EXISTING SERVICES/SYSTEMS: MAINTAIN EXISTING SERVICES AND PROTECT THEM AGAINST DAMAGE DURING SELECTIVE DEMOLITION OPERATIONS.

2. SERVICE/SYSTEM REQUIREMENTS: LOCATE, IDENTIFY, DISCONNECT AND SEAL OR CAP OFF INDICATED UTILITY SERVICES AND MECHANICAL/ELECTRICAL SYSTEMS SERVICING AREAS TO BE SELECTIVELY DEMOLISHED.

# MASONRY

1. DEMOLISH IN SMALL SECTIONS. CUT MASONRY AT JUNCTURES WITH CONSTRUCTION TO REMAIN, USING POWER-DRIVEN SAW, THEN REMOVE MASONRY BETWEEN SAW CUTS.

CLEANING

1. CLEAN ADJACENT STRUCTURES AND IMPROVEMENTS OF DUST, DIRT AND DEBRIS CAUSED BY SELECTIVE DEMOLITION OPERATIONS. RETURN ADJACENT AREAS TO CONDITION EXISTING BEFORE SELECTIVE DEMOLITION

# TEMPORARY SHORING

1. PROVIDE AND MAINTAIN SHORING, BRACING AND STRUCTURAL SUPPORTS AS REQUIRED TO PRESERVE STABILITY AND PREVENT MOVEMENT, SETTLEMENT, OR COLLAPSE OF CONSTRUCTION AND FINISHES TO REMAIN, AND TO PREVENT UNEXPECTED OR UNCONTROLLED MOVEMENT OR COLLAPSE OF CONSTRUCTION BEING DEMOLISHED. STRENGTHEN OR ADD NEW SUPPORTS WHEN REQUIRED DURING PROGRESS OF SELECTIVE DEMOLITION.

# PLAN DEMOLITION LEGEND

- 1 DEMOLISH AND REMOVE EXISTING FLOOR TILE COMPLETE.
- 2 DEMOLISH AND REMOVE EXISTING WALL TILE COMPLETE
- 3 REMOVE EXISTING PLUMBING FIXTURE AND PREPARE PLUMBING FOR NEW FIXTURE
- (4) REMOVE EXISTING DOOR AND FRAME
- 5 REMOVE EXISTING WALL
- REMOVE EXISTING VANITY COMPLETE
- 7 REMOVE EXISTING TOILET PARTITION
- 8 EXISTING PLUMBING FIXTURE TO REMAIN
- 9 EXISTING FLOOR TILE TO REMAIN, PATCH AND REPAIR TO MATCH EXISTING
- (10) REMOVE EXISTING DRINKING FOUNTAIN COMPLETE

**STUDIO 2LR, INC.**801 GERVAIS ST. SUITE COLUMBIA, SOUTH CAF P 803.233.6602 F 802.2 STUDIO2LR.COM

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T NAME

TED PARK BATHROOM

OVATION

REVISIONS

NO. DATE DESCRIPTION

PROJECT NUMBER 15012

SHEET NUMBER
AD102


SHEET NAME

DEMOLITION FLOOR

PLANS

DATE **05/06/2015** 


PLAN NORTH

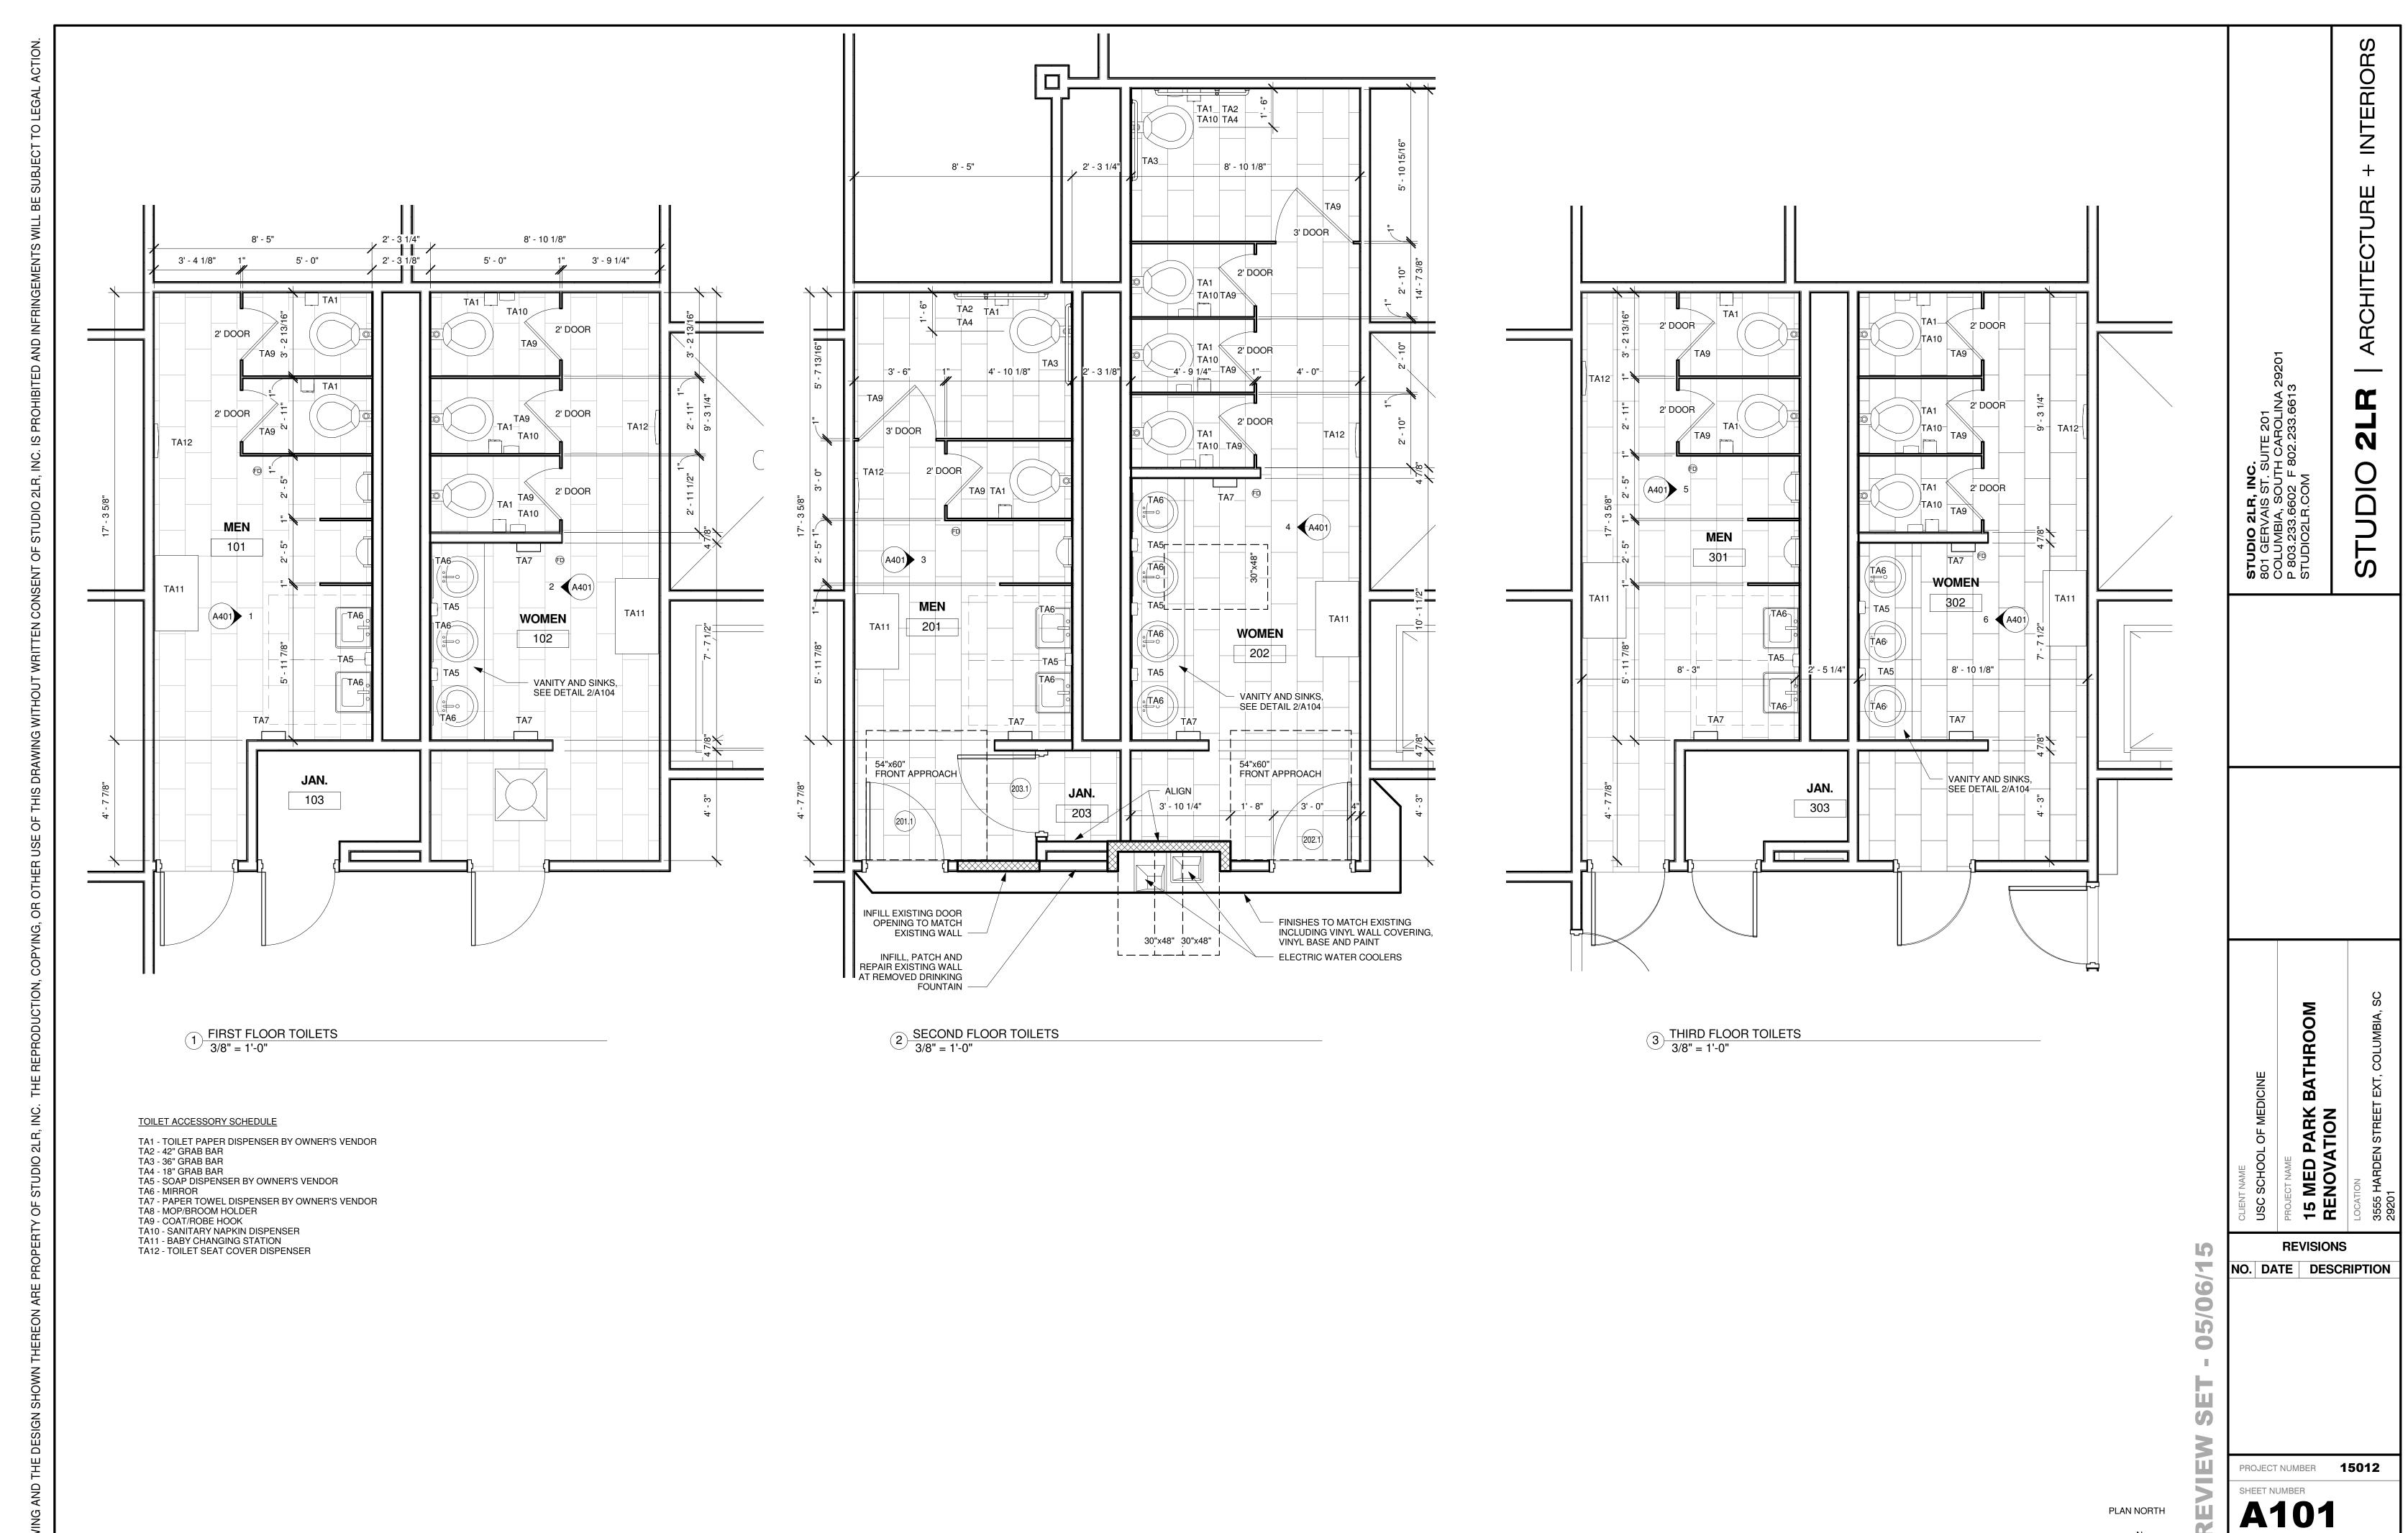


SHEET NAME **FLOOR PLANS** 

REFLECTED CEILING PLANS ALTERNATE 1 DATE **05/06/2015** 

								DOC	R SCHED	ULE			
	S	IZE		DOOR				FRAM	E				
NUMBER	WIDTH	HEIGHT	TYPE	MATERIA L	FINISH	FIRE RATING	TYPE	MATERI AL	FINISH	HEAD	JAMB	SILL	COMMENTS
201.1	3' - 0"	7' - 0"	Α	WOOD	STAIN		1	HM	PAINT	H1	J1	*	*SEE CARPET TO TILE TRANSITION ON A901
202.1	3' - 0"	7' - 0"	Α	WOOD	STAIN		1	НМ	PAINT	H1	J1	-	
203.1	3' - 0"	7' - 0"	Α	WOOD	STAIN		1	НМ	PAINT	H1	J1	*	*SEE CARPET TO TILE TRANSITION ON A901

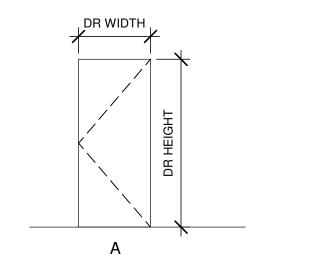

2 DOOR TYPES
1/4" = 1'-0"

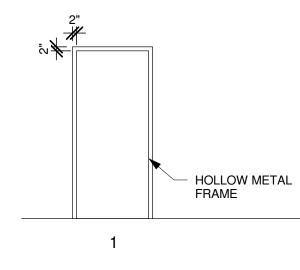

3 FRAME TYPES 1/4" = 1'-0"

**GENERAL DOOR NOTES** 

1. ALL DOORS TO BE LOCATED 6" FROM ADJACENT PERPENDICULAR WALL TO INSIDE FACE OF FRAME, UNLESS NOTED OTHERWISE. THIS DOES NOT APPLY TO STOREFRONT ITEMS.

2. HEAD, JAMB AND SILL DETAILS SHOWN FOR REFERENCE ONLY. COORDINATE WITH MANUFACTURER'S REQUIREMENTS, STRUCTURAL DRAWINGS, AND PARTITION TYPES.

3. ALL WOOD DOORS TO BE FLUSH. WOOD DOORS TO BE 5-PLY PREMIUM GRADE, BONDED CORE IN ACCORDANCE WITH THE WINDOW AND DOOR MANUFACTURERS ASSOCIATION ARCHITECTURAL WOOD FLUSH DOORS

4. STEEL DOORS AND FRAMES: FABRICATE FRAMES OF MINIMUM 16 GAUGE COLD-ROLLED STEEL, DOUBLE RABBET PROFILE, MITERED CORNERS. PROVIDE FULLY WELDED FRAMES AT ALL H.M. DOORS.

5. COMPLY WITH NFPA 80 FOR FIRE RATED ASSEMBLIES.

6. DOOR HARDWARE ALLOWANCE: \$--- PER LEAF, MATCH EXISTING HARDWARE IF APPLICABLE AND COORDINATE WITH OWNER.


NO. DATE DESCRIPTION

PROJECT NUMBER 15012

SHEET NUMBER
A801

DOOR SCHEDULE

FINISH SPECIFICATION									
TAG	ITEM	MANUFACTURER	DESCRIPTION	SIZE	NOTES				
TILE (T)									
T1	PORCELAIN TILE	CROSSVILLE	PATTERN: BASALT; COLOR: SILICA AV291	12"L X 24"W; 3/8" THICK	INSTALL IN RUNNING BOND PATTERN. USE WITH GT1.				
GROUT (GT)									
GT1	GROUT	CUSTOM BUILDING	ITEM: UNSANDED GROUT; COLOR: #386 OYSTER GRAY	1/4" GROUT JOINT	USE WITH T1				
PAINT (P)									
P1	WALL PAINT	SHERWIN WILLIAMS	COLOR:SW7042 WORDLY GREY; FINISH: SATIN						
P2	CEILING PAINT	SHERWIN WILLIAMS	COLOR: SW7005 PURE WHITE; FINISH: FLAT						
PLASTIC LAMINATE (PL)									
PL1	PLASTIC LAMINATE	FORMICA	PATTERN:CHESTNUT WOODLINE 5884-58; FINISH: MATTE	4'W X 8'L					
COUNTERTOP (C)									
C1	SOLID SURFACE	CORIAN	PATTERN: CONCRETE; FINISH: STANDARD	144"L X 30"W X 1/2" THICK					
BASE (B)									
B1	TILE COVE BASE	CROSSVILLE	PATTERN: BASALT; COLOR: SILICA AV291	6"H X 12"LX 3/8" THICK					
ACOUSTICAL CEILING TILE									
ACT1	ACOUSTICAL CEILING TILE	ARMSTRONG	PATTERN: CIRRUS SQUARE LAY IN TEGULAR; COLOR: WHITE	24"W X 24"LX 3/4" THICK					

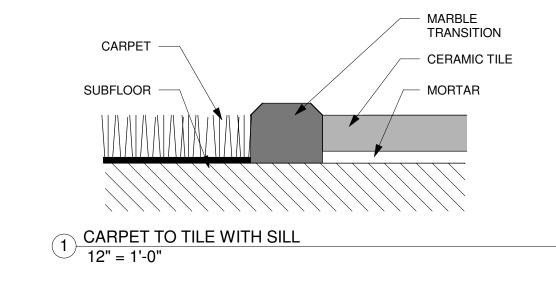

ARCHITEC


INTERIORS

NO. DATE DESCRIPTION


PROJECT NUMBER 15012

FINISH SCHEDULE



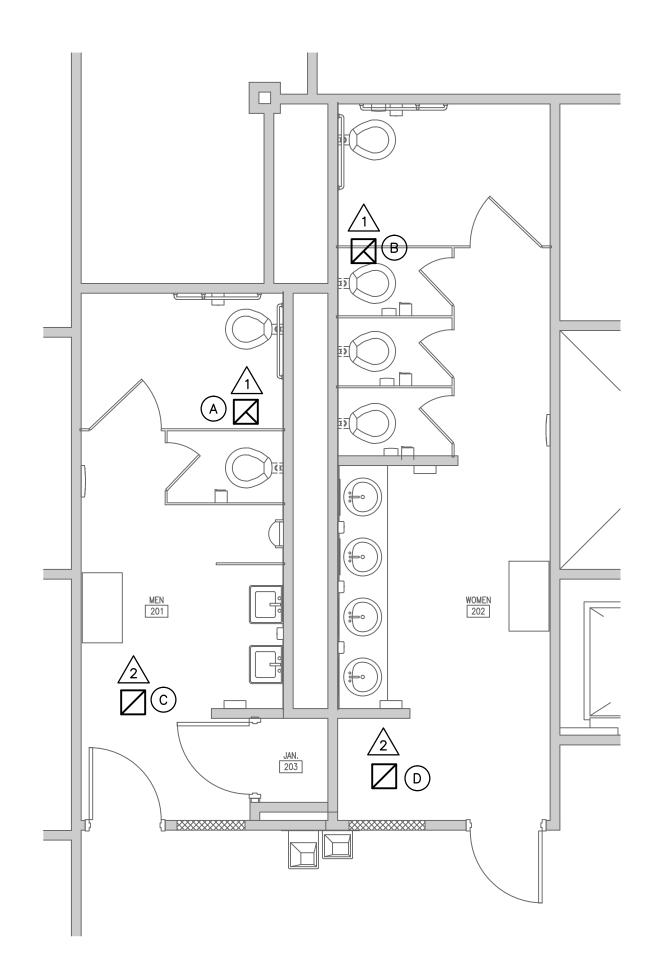


3 SECOND FLC
M101 SCALE: 1/4" = 1'-0" SECOND FLOOR RENOVATION PLAN

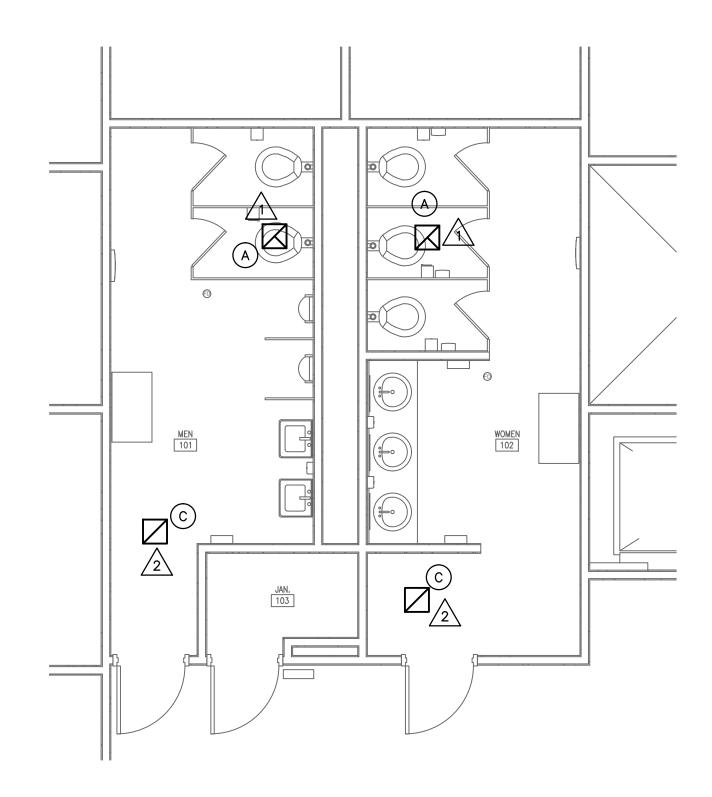

FIRST FLOOR RENOVATION PLAN SCALE: 1/4" = 1'-0"

NOTE:
ALL WORK ASSOCIATED
WITH THIS SHEET IS
PART OF ALTERNATE 1.

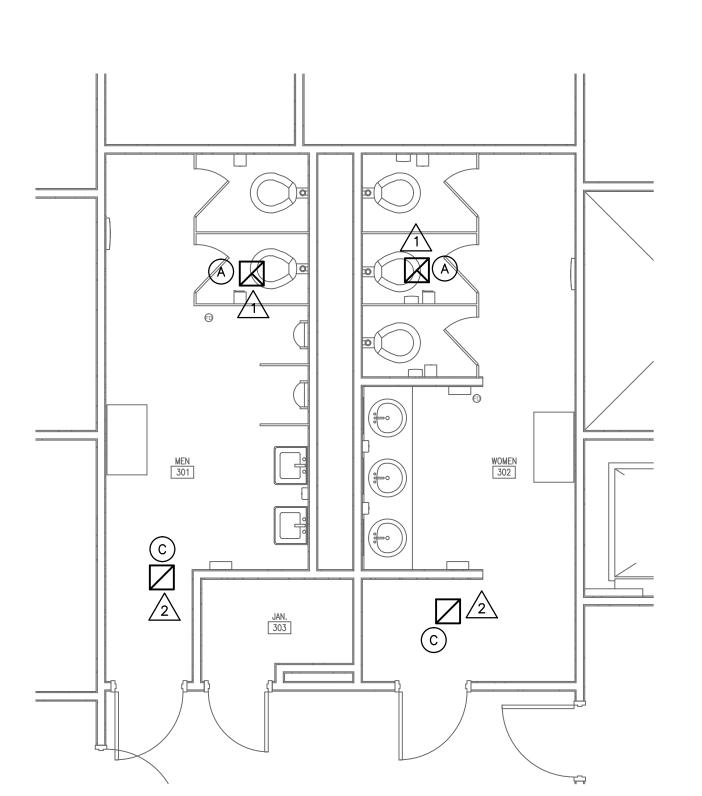

THIRD FLOOR RENOVATION PLAN SCALE: 1/4" = 1'-0"

# NOTES TO SHEET

INSTALL NEW EXHAUST GRILLE IN NEW ACOUSTICAL CEILING TILE GRID PER THE AIR DISTRIBUTION SCHEDULE AND EXTEND DUCTWORK FULL SIZE OF NECK TO EXISTING DUCTWORK AND TRANSITION AS REQUIRED.

INSTALL NEW TRANSFER GRILLE IN NEW ACOUSTICAL CEILING TILE GRID PER THE AIR DISTRIBUTION SCHEDULE AND EXTEND DUCTWORK FULL SIZE OF NECK TO EXISTING DUCTWORK AND TRANSITION AS REQUIRED.

INSTALL NEW EXHAUST FAN IN NEW ACOUSTICAL CEILING TILE. EXTEND DUCTWORK FULL SIZE TO EXISTING DUCTWORK AND TRANSITION AS REQUIRED. RECONNECT EXISTING ELECTRICAL SERVICE TO NEW EXHAUST FAN AS REQUIRED.



BATHROOM

REVISIONS

NO. DATE DESCRIPTION

PROJECT NUMBER

SHEET NUMBER

M101

SHEET NAME
RENOVATION FLOOR PLANS - ALTERNATE 1

Swygert & Associates CONSULTING ENGINEERS

DATE 08/07/2015

3. ALL DUCTWORK LOCATIONS SHALL BE COORDINATED WITH WORK UNDER OTHER DIVISIONS OF THE SPECIFICATIONS TO AVOID INTERFERENCE.

4. THIS CONTRACTOR SHALL PROVIDE ALL ITEMS OF MISCELLANEOUS STEEL AS REQUIRED FOR INSTALLATION OF ALL MECHANICAL ITEMS.

5. THIS CONTRACTOR SHALL BE RESPONSIBLE FOR ANY NECESSARY DISMANTLING OF EQUIPMENT TO BE REMOVED.

6. ITEMS REMOVED UNDER THIS CONTRACT SHALL BECOME THE PROPERTY OF THE CONTRACTOR AND SHALL BE DISPOSED OF PROPERLY.

	LEGEND
SYMBOL	DESCRIPTION
<b>(</b> A)100	TYPE "A" DIFFUSER, 100 CFM
•	CONNECTION POINT OF NEW TO EXISTING


AIR DISTRIBUTION SCHEDULE DESCRIPTION MANUFACTURER MODEL FRAME CFM NECK SIZE FACE SIZE MAX NC REMARKS PERFORATED EXHAUST APDDR LAY-IN 251-350 10"x10" 24"x24" 1,2,3 PRICE 30 PERFORATED EXHAUST PRICE APDDR LAY-IN 351-450 12"x12" 24"x24" 1,2,3 30 PERFORATED RETURN PRICE APDDR LAY-IN 10"x10" 24"x24" 30 1,2 PERFORATED RETURN 12"x12" 24"x24" APDDR LAY-IN 30 1,2 PRICE

. PROVIDE WITH STANDARD WHITE FINISH. 2. PROVIDE ALUMINUM OR ALUMINIZED STEEL CONSTRUCTION. 3. PROVIDE WITH OPPOSED BLADE DAMPER.


EXHAUST FAN SCHEDULE									
TAG	GREENHECK MODEL NO.	TYPE	CFM	ESP	MOTOR H.P./W	SONES (MAX.)	REMARKS		
EF-1	SP-B150	CEILING	140	0.375	150W	2.5	1,2		
EF-2	SP-B150	CEILING	140	0.375	150W	2.5	1,2		

1. PROVIDE WITH CEILING GRILLE, BACKDRAFT DAMPER, DISCONNECT SWITCH, AND SPEED CONTROL LOCATED ON FAN.

2. INTERLOCKED WITH LIGHT SWITCH, WIRED BY ELECTRICAL CONTRACTOR.

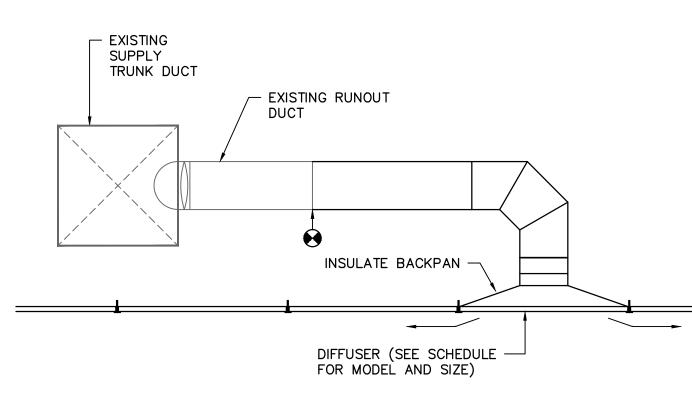


CEILING TRANSFER GRILLE DETAIL NO SCALE

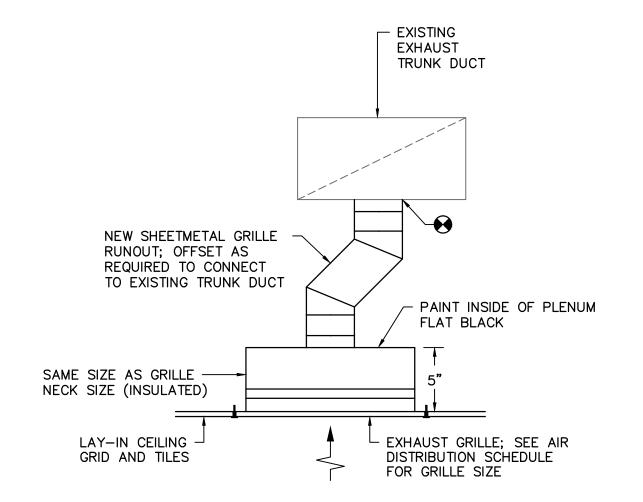

EXHAUST GRILLE DETAIL

NO SCALE

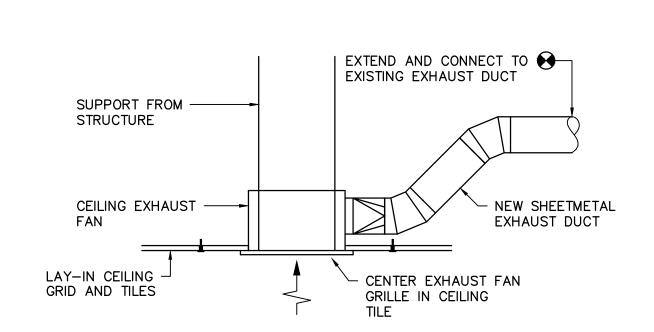

EXHAUST FAN DETAIL

NO SCALE

INTERIORS

BATHROOM

15 MED PARK I RENOVATION

REVISIONS

NO. DATE DESCRIPTION

PROJECT NUMBER 15012

SHEET NUMBER M201


DETAILS, NOTES, SCHEDULES, AND LEGEND DATE 08/07/2015

Swygert & Associates CONSULTING ENGINEERS


DBA Swygert & Assoc., Ltd.
Post Office Box 11686
Columbia, S.C. 29211

Telephone: (803) 791-9300
Facsimile: (803) 791-0830
mail@swygert-associates.com




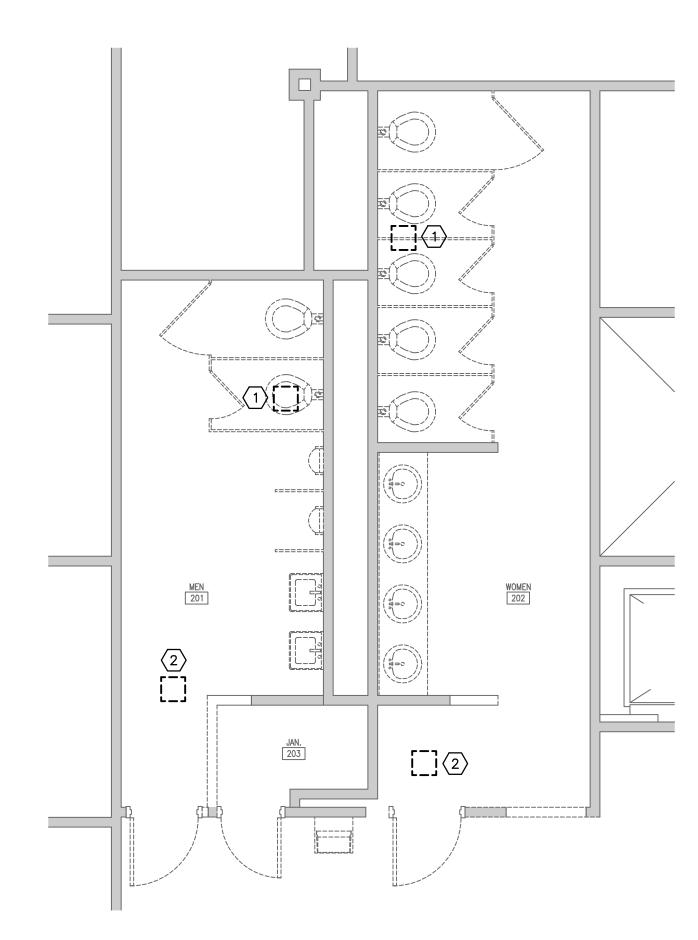

3 SECOND FLC
MD101 SCALE: 1/4" = 1'-0" SECOND FLOOR DEMOLITION PLAN

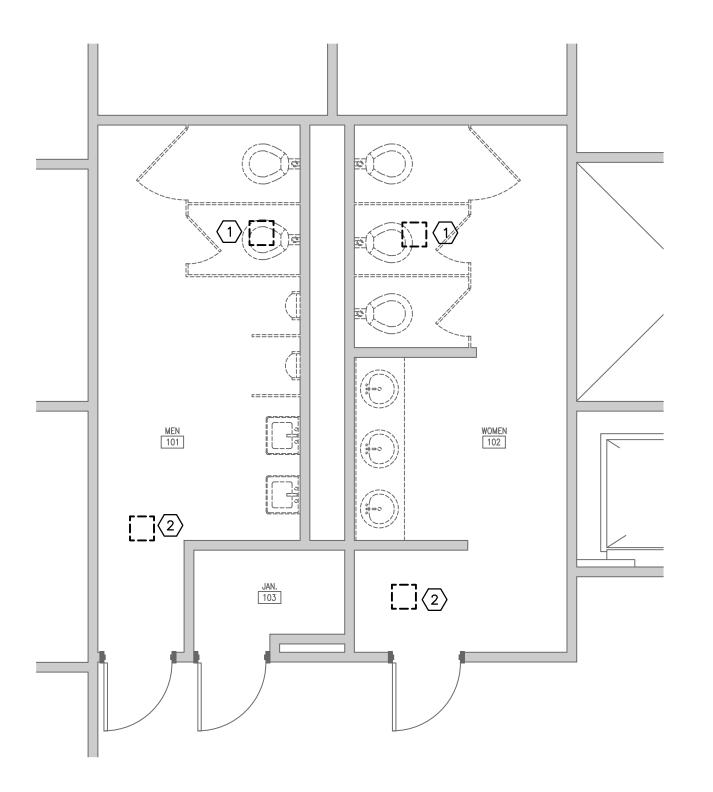

FIRST FLOOR DEMOLITION PLAN SCALE: 1/4" = 1'-0"

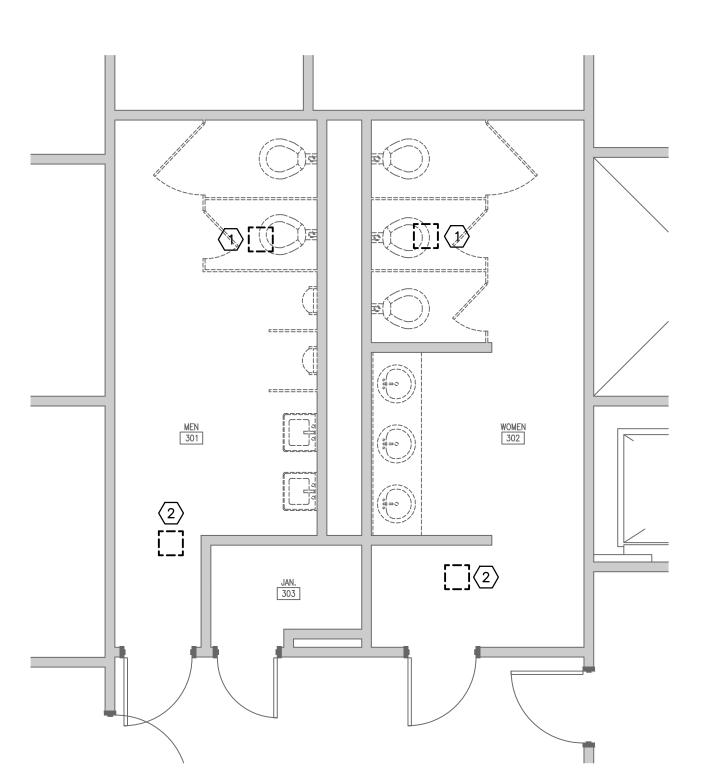


THIRD FLOOR DEMOLITION PLAN SCALE: 1/4" = 1'-0"

# DEMOLITION NOTES

- $\fbox{1}$  EXISTING EXHAUST GRILLE TO BE REMOVED COMPLETELY. EXISTING DUCTWORK TO REMAIN IN PLACE FOR CONNECTION TO NEW.
- 2 EXISTING TRANSFER GRILLE TO BE REMOVED COMPLETELY. EXISTING DUCTWORK TO REMAIN IN PLACE FOR CONNECTION TO NEW.
- EXISTING CEILING MOUNTED EXHAUST FAN TO BE REMOVED COMPLETELY. EXISTING DUCTWORK TO REMAIN IN PLACE FOR CONNECTION TO NEW. SEE RENOVATION PLANS FOR NEW EXHAUST FAN.

NOTE:
ALL WORK ASSOCIATED
WITH THIS SHEET IS
PART OF ALTERNATE 1.

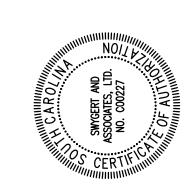

BATHROOM

REVISIONS


NO. DATE DESCRIPTION

PROJECT NUMBER SHEET NUMBER

MD101


SHEET NAME
DEMOLITION FLOOR
PLANS - ALTERNATE 1 DATE 08/07/2015

Swygert & Associates CONSULTING ENGINEERS

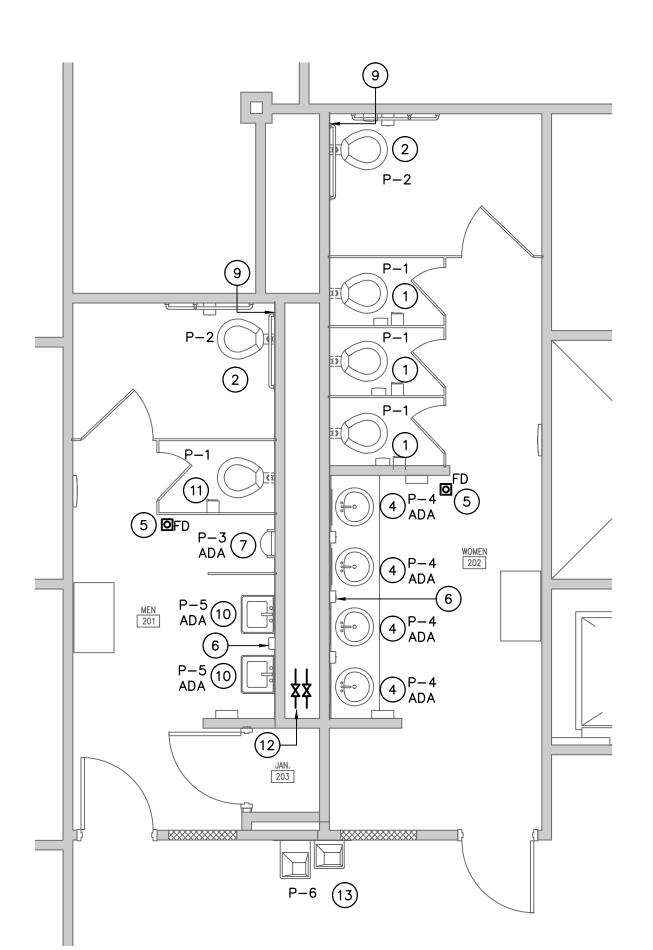


SECOND FLOOR RENOVATION PLAN

P101 SCALE: 1/4" = 1'-0"

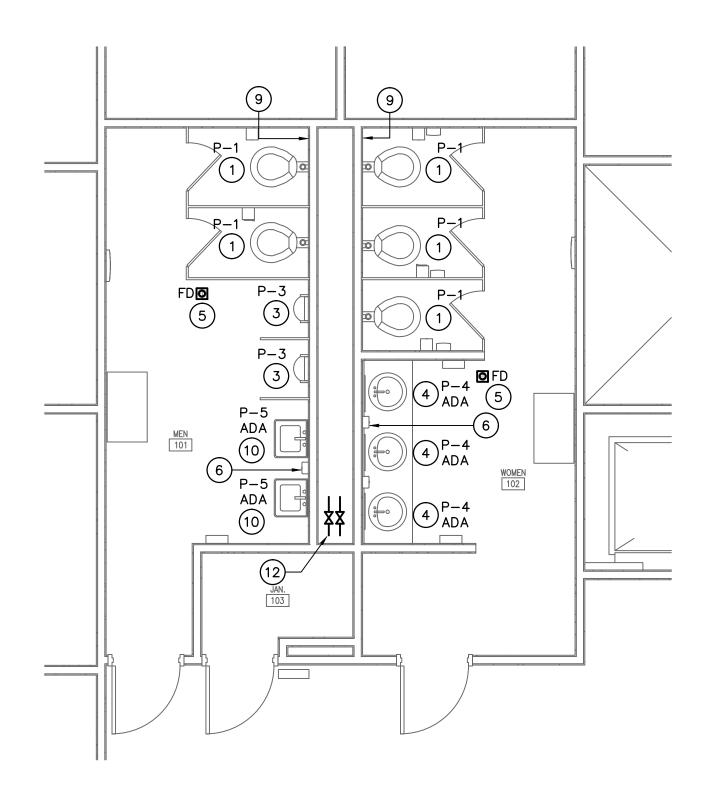




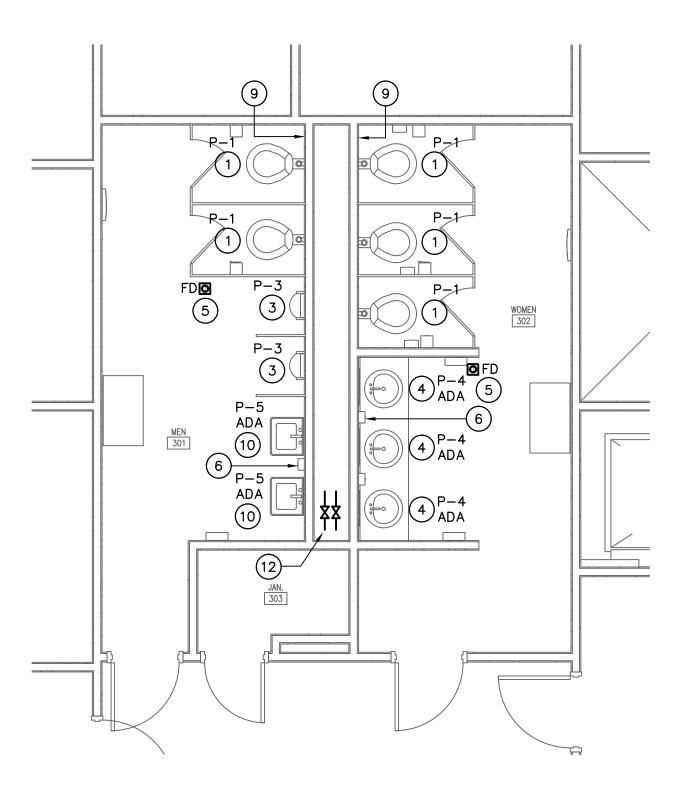


THIRD FLOOR RENOVATION PLAN

P101 SCALE: 1/4" = 1'-0"

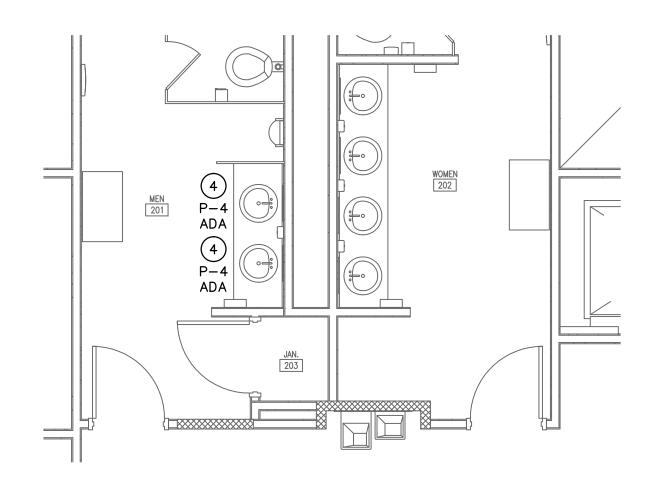

ALTERNATE #2
FIRST FLOOR RENOVATION PLAN SCALE: 1/4" = 1'-0"

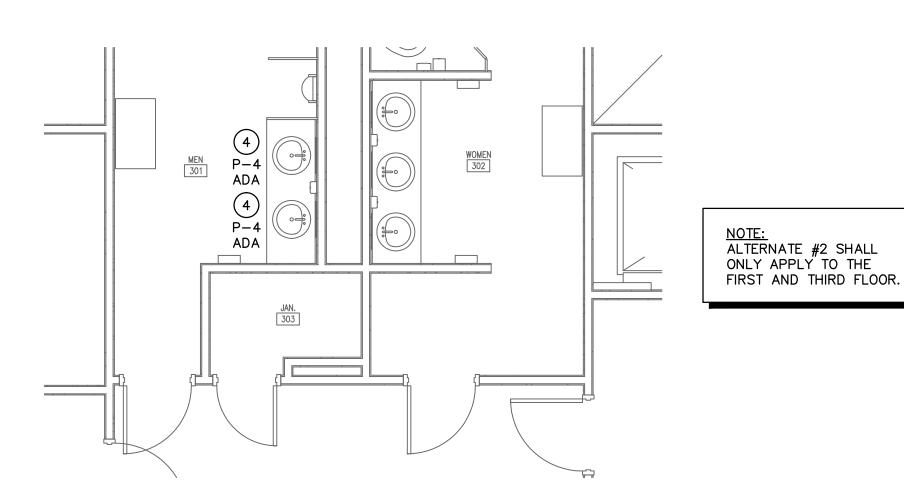


ALTERNATE #2
THIRD FLOOR RENOVATION PLAN SCALE: 1/4" = 1'-0"

# NOTES TO SHEET

- 1) INSTALL NEW WALL MOUNTED WATER CLOSET AND FLUSH VALVE AS SPECIFIED IN THE PLUMBING FIXTURE SCHEDULE. RECONNECT TO EXISTING CHAIR CARRIER, SUPPLY, WASTE, AND VENT PIPING. TRANSITION AS REQUIRED.
- 2 INSTALL NEW WALL MOUNTED WATER CLOSET, FLUSH VALVE, AND CHAIR CARRIER AS SPECIFIED IN THE PLUMBING FIXTURE SCHEDULE. RECONNECT TO EXISTING SUPPLY, WASTE, AND VENT PIPING. TRANSITION AS REQUIRED. NEW FIXTURE IS FOR USE PER THE ADA REQUIREMENTS AND THE OPERATING HANDLE SHALL BE ON THE WIDE SIDE OF THE BATHROOM STALL WHERE APPLICABLE AND HEIGHT OF FIXTURE TO BE ADJUSTED.
- 3 INSTALL NEW WALL HUNG URINAL AND FLUSH VALVE AS SPECIFIED IN THE PLUMBING FIXTURE SCHEDULE. RECONNECT TO EXISTING CHAIR CARRIER, SUPPLY, WASTE, AND VENT PIPING. TRANSITION AS REQUIRED.
- (4) INSTALL NEW COUNTERTOP LAVATORY, SENSOR FAUCET, SUPPLY LINES, AND P-TRAP AS SPECIFIED IN THE PLUMBING FIXTURE SCHEDULE. RECONNECT TO EXISTING SUPPLY, WASTE, AND VENT PIPING. TRANSITION AS REQUIRED.
- 5) INSTALL NEW FLOOR DRAIN. RECONNECT TO EXISTING WASTE LINE. TRANSITION AS REQUIRED.
- 6 INSTALL NEW HOSE BIB. RECONNECT TO EXISTING SUPPLY LINE. TRANSITION AS REQUIRED.
- 7 INSTALL WALL HUNG URINAL, FLUSH VALVE, AND CHAIR CARRIER AS SPECIFIED IN THE PLUMBING FIXTURE SCHEDULE. RECONNECT TO EXISTING SUPPLY, WASTE, AND VENT PIPING. TRANSITION AS REQUIRED. NEW FIXTURE IS FOR USE PER THE ADA REQUIREMENTS AT A LOWER HEIGHT AND WASTE AND SUPPLY LINES SHALL BE LOWERED IN THE WALL AS REQUIRED.
- (8) NOT USED.
- (9) REINSTALL EXISTING WALL CLEANOUT PLATE AFTER INSTALLATION OF NEW TILE.
- 10 INSTALL NEW WALL HUNG LAVATORY, SENSOR FAUCET, SUPPLY LINES, AND P-TRAP AS SPECIFIED IN THE PLUMBING FIXTURE SCHEDULE. RECONNECT TO EXISTING SUPPLY, WASTE, AND VENT PIPING. TRANSITION AS REQUIRED.
- 11) INSTALL NEW WALL MOUNTED WATER CLOSET, FLUSH VALVE, AND CHAIR CARRIER AT NEW LOCATION. RECONNECT TO EXISTING SUPPLY, WASTE, AND VENT PIPING. TRANSITION AS REQUIRED.
- 12) INSTALL NEW 21" COLD WATER AND 1" HOT WATER SHUT OFF VALVES IN CHASE WITH NEW BALL VALVES. CONNECT TO EXISTING PIPING WATER TIGHT. INSULATE PER THE SPECIFICATIONS.
- 13) INSTALL NEW DRINKING FOUNTAIN PER THE PLUMBING FIXTURE SCHEDULE. RECONNECT TO EXISTING WASTE, VENT, AND SUPPLY PIPING. TRANSITION AS REQUIRED.



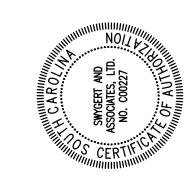

BATHROOM

REVISIONS NO. DATE DESCRIPTION

PROJECT NUMBER

SHEET NUMBER

P101


SHEET NAME RENOVATION FLOOR

DATE 08/07/2015

Swygert & Associates CONSULTING ENGINEERS


# TYPICAL URINAL SUPPORT

NO SCALE

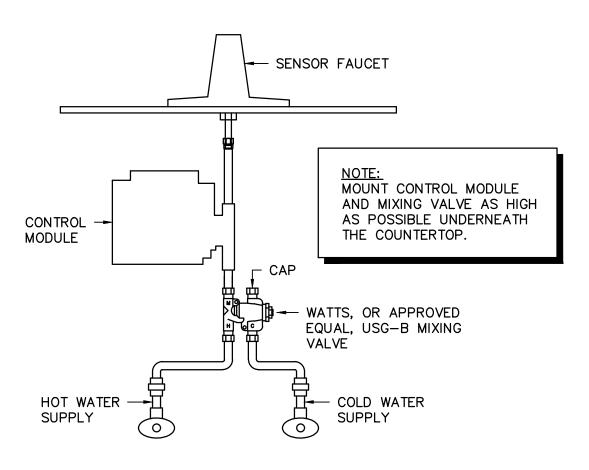


# LAVATORY MIXING VALVE DETAIL

NO SCALE

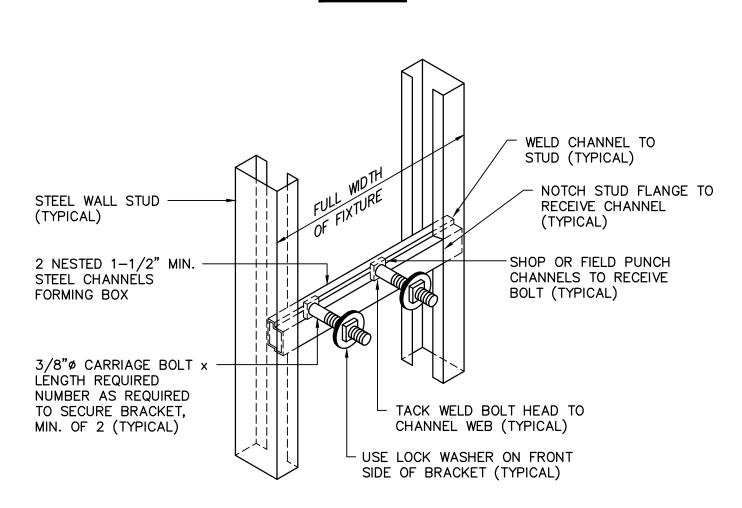

CHANNEL BACK-UP ASSEMBLY

NO SCALE

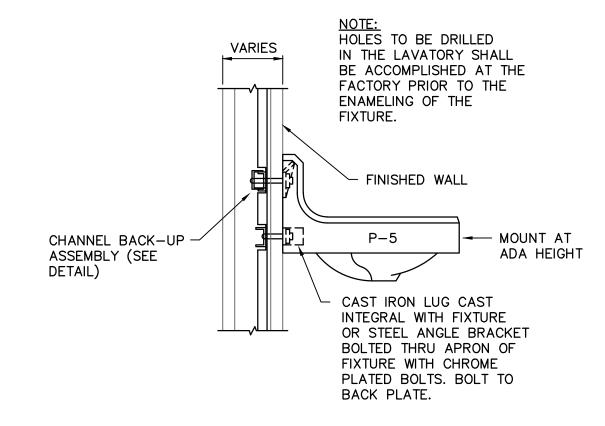

NO SCALE



CAULK AROUND PERIMETER
 OF WALL MOUNTED FIXTURE

PLUMBING FIXTURE SCHEDULE

SIZE

- - -

19r"x16r"

19"x17"

- - -

- - -

MFGRS. NO.

K-4325

K-4325

K-5016-ET

K-2210

K-2805-1

P8ACSL

MODEL 24

ZN-415-S

FIXTURE

WATER CLOSET

ACCESSIBLE

WATER CLOSET

URINAL

COUNTERTOP

LAVATORY

LAVATORY

ELECTRIC WATER

COOLER

HOSE BIB

FLOOR DRAIN

FD

P-2

P-3

P-4

MFGR.

KOHLER

KOHLER

KOHLER

KOHLER

KOHLER

OASIS

WOODFORD

ZURN

KINGSTON

KINGSTON

DEXTER

CAXTON

HUDSON

- - -

NOTE: SEE ARCHITECTURAL DRAWINGS FOR MOUNTING HEIGHTS OF ALL WALL MOUNTED FIXTURES.

SUPPLY PIPE

CLOSET CARRIER -

SUPPORT

ASSEMBLY

MIN. SUPPLY

CW HW

3/8" 3/8"

3/4"

3/8"

3/8"

3/4"

→ FINISHED WALL

ELECTRONIC

VALVE

SENSOR FLUSH

REMARKS

WITH SLOAN MODEL 8111-1.28

527 SEAT, AND BOLT CAPS.

527 SEAT, AND BOLT CAPS.

WITH SLOAN MODEL 8186-0.5

WITH SLOAN MODEL SF-2250

APPROVED EQUAL, SERIES USG-

B MIXING VALVE, McGUIRE 155A

GRID DRAIN, McGUIRE H165 3/8'

CAST BRASS SUPPLIES WITH

STOPS, AND McGUIRE 8872 1-1/4" P-TRAP. MOUNT MIXING VALVE AS HIGH AS POSSIBLE

AND McGUIRE 8872 1-1/4"

WITH SLOAN MODEL SF-2250

APPROVED EQUAL, SERIES USG-

B MIXING VALVE, McGUIRE 155A

GRID DRAIN, McGUIRE H165 3/8'

CAST BRASS SUPPLIES WITH

VALVE AS HIGH AS POSSIBLE

STOPS, AND McGUIRE 8872 1-1/4" P-TRAP. MOUNT MIXING

AND McGUIRE 8872 1-1/4" P-TRAP. MOUNT PER ADA

WITH STAINLESS STEEL FINISH

STAINLESS STEELCANE TOUCH

MOUNTED 18" ABOVE FINISHED

WITH 5"x5" SQUARE NICKEL

BRONZE STRAINER, P-TRAP, AND TRAP GUARD BY PROSET

SUPPLY PIPE -

SUPPORT

CLOSET CARRIER

**ASSEMBLY** 

STANDARD (15" TO TOP OF SEAT)

ADA (18" TÒ TOP OF SEAT)

OR APPROVED EQUAL.

APRON, McGUIRE H165 3/8" CAST BRASS SUPPLY WITH STOP AND McGUIRE 8872 1-1/4" P-TRAP. MOUNT PER ÁDA

UNDER COUNTERTOP.

REQUIREMENTS.

REQUIREMENTS.

FLOOR.

BATTERY POWERED SENSOR

FAUCET AND WATTS, OR

UNDER COUNTERTOP.

BATTERY POWERED SENSOR FAUCET AND WATTS, OR

FLUSH VALVE, AND CHAIR

UNDERCOUNTER MOUNTED

CARRIER.

P-TRAP.

WITH SLOAN MODEL 8111-1.28

SENSOR FLUSH VALVE, BENEKE

SENSOR FLUSH VALVE, BENEKE

# GENERAL NOTES


- ALL WORK SHALL BE PERFORMED ACCORDING TO ALL LOCAL, STATE, NATIONAL CODES, AND THE 2012 INTERNATIONAL PLUMBING CODE.
- 2. DO NOT SCALE DRAWINGS. SEE ARCHITECTURAL DRAWINGS FOR EXACT DIMENSIONS, FIXTURE LOCATIONS, ETC.
- 3. EXCEPT WHERE PIPE SPACE IS PROVIDED OR UNLESS NOTED OTHERWISE, ALL
- 4. COORDINATE CLOSELY WITH ALL WORK DONE UNDER OTHER DIVISIONS OF THE SPECIFICATIONS TO AVOID INTERFERENCE AND CONFLICT.
- 5. EXPOSED WASTE AND WATER PIPING UNDER LAVATORIES MARKED "ADA" SHALL BE INSULATED WITH HANDI LAV-GUARD KIT MODEL NUMBER 102W AS MANUFACTURED BY TRUEBRO, INC., OR APPROVED EQUAL.


SUPPLY, WASTE AND VENT RISERS SHALL BE RUN IN WALLS AND PARTITIONS.

- 6. ALL PIPING INSULATION SHALL BE RUN CONTINUOUSLY.
- 7. EXISTING FLOOR SLAB SHALL BE "SAW-CUT" FOR INSTALLATION OF NEW SEWER LINES. THIS CONTRACTOR SHALL PATCH AND FILL FOR CONCRETE FINISH BY OTHERS.

LEGEND								
SYMBOL	DESCRIPTION							
<b>├</b> ── - ── <b>२</b>	DOMESTIC COLD WATER LINE							
<b>├  </b>	DOMESTIC HOT WATER LINE							
$\longleftarrow \bowtie \longrightarrow$	SHUTOFF VALVE							
<b>ر</b>	PIPE TURNS TO, AWAY							
FD FD	FLOOR DRAIN							
ADA	FIXTURE FOR USE ACCORDING TO THE AMERICANS WITH DISABILITIES ACT							
<b>€</b>	CONNECTION POINT OF NEW TO EXISTING							

ARCHITE

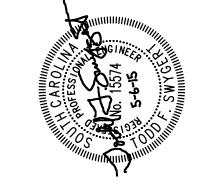

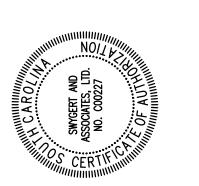

BATHROOM

PROJECT NAWL

15 MED

RENOV

REVISIONS NO. DATE DESCRIPTION

PROJECT NUMBER 15012 SHEET NUMBER

P201


Swygert & Associates

CONSULTING ENGINEERS

DBA Swygert & Assoc., Ltd. Telephone: (803) 791-9300 Facsimile: (803) 791-0830 mail@swygert-associates.com


**DETAILS, NOTES,** SCHEDULE, AND LEGEND DATE 08/07/2015

LAVATORY MOUNTING DETAIL

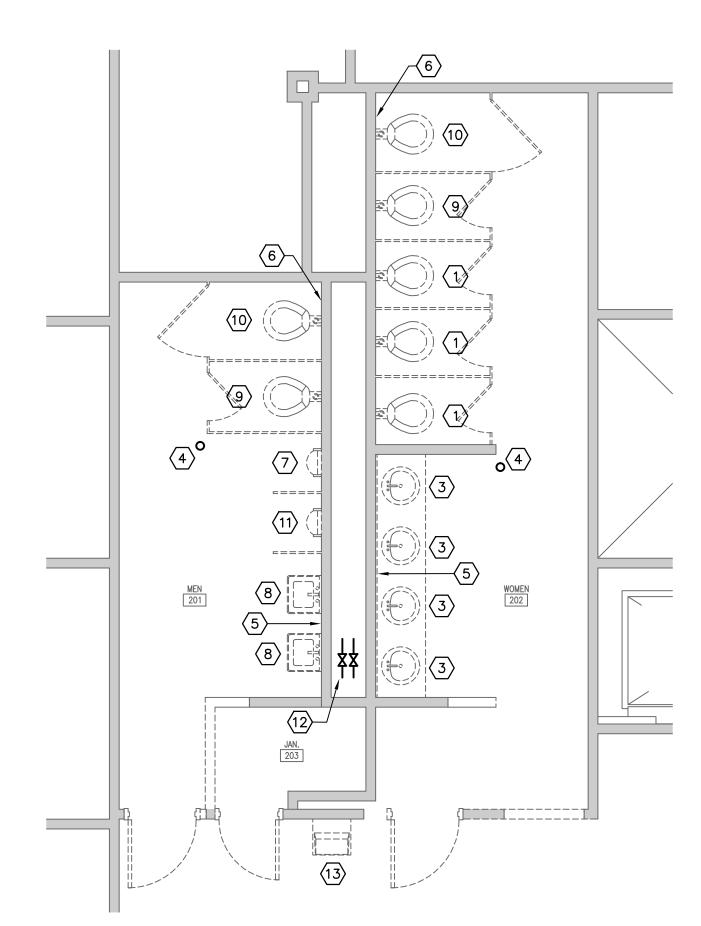


SECOND FLOOR DEMOLITION PLAN

PD101 SCALE: 1/4" = 1'-0"

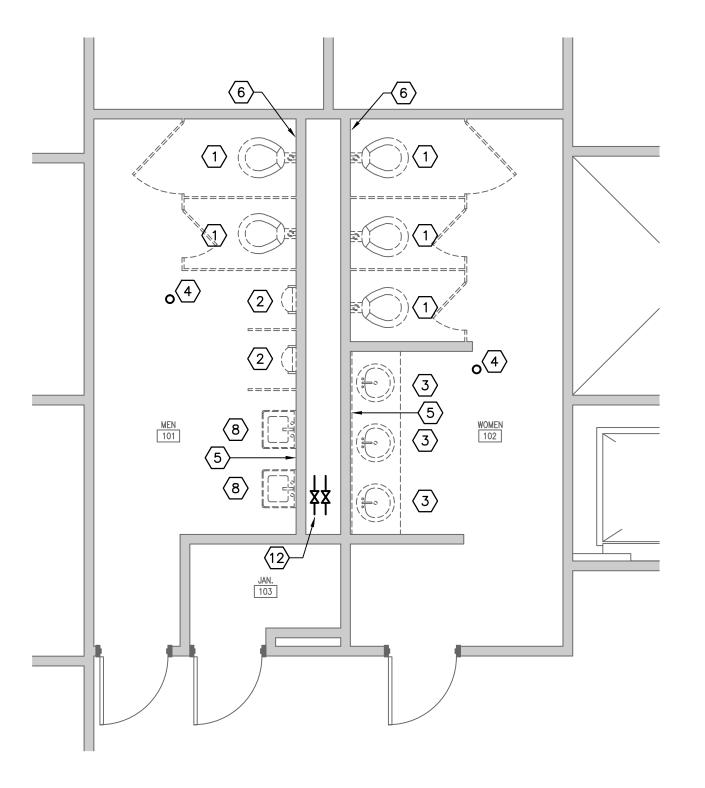

FIRST FLOOR DEMOLITION PLAN SCALE: 1/4" = 1'-0"

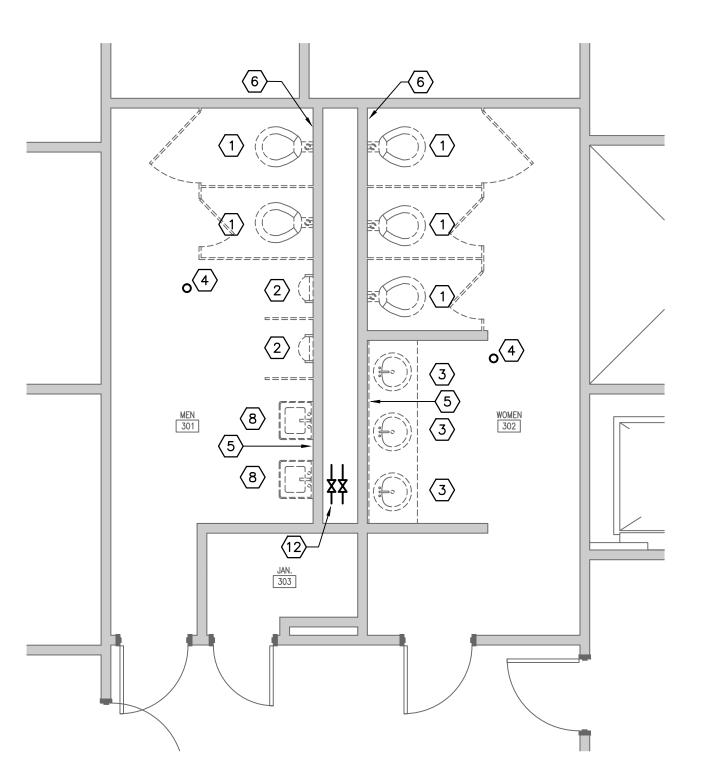



THIRD FLOOR DEMOLITION PLAN SCALE: 1/4" = 1'-0"

# **DEMOLITION NOTES**

- 1) EXISTING WALL MOUNTED WATER CLOSET TO BE REMOVED COMPLETELY INCLUDING FLUSH VALVE. EXISTING CHAIR CARRIER, SUPPLY, WASTE, AND VENT PIPING TO BE REUSED FOR NEW FIXTURE.
- 2) EXISTING WALL HUNG URINAL TO BE REMOVED COMPLETELY INCLUDING FLUSH VALVE. EXISTING CHAIR CARRIER, SUPPLY, WASTE, AND VENT PIPING TO BE REUSED FOR NEW FIXTURE.
- 3 EXISTING COUNTERTOP LAVATORY TO BE REMOVED COMPLETELY INCLUDING FAUCET, SUPPLY TUBING, AND P-TRAP. COORDINATE WITH DEMOLITION OF COUNTERTOP BEING HANDLED BY GENERAL CONTRACTOR. EXISTING SUPPLY, WASTE, AND VENT PIPING TO BE REUSED FOR NEW FIXTURE.
- 4 EXISTING FLOOR DRAIN TO BE REMOVED. EXISTING WASTE PIPING TO BE REUSED FOR NEW FLOOR DRAIN.
- 5 EXISTING HOSE BIB TO BE REMOVED. EXISTING SUPPLY PIPING TO BE REUSED FOR NEW HOSE BIB.
- 6 EXISTING WALL CLEANOUT TO BE REMOVED FOR NEW TILE WORK.
- (7) EXISTING WALL HUNG URINAL AND FLUSH VALVE TO BE REMOVED COMPLETELY. CAP ALL EXISTING PIPING WATER TIGHT AS REQUIRED.
- 8 EXISTING WALL HUNG LAVATORY TO BE REMOVED COMPLETELY INCLUDING FAUCET, SUPPLY TUBING, AND P-TRAP. EXISTING SUPPLY, WASTE, AND VENT PIPING TO BE REUSED FOR NEW FIXTURE.
- 9 EXISTING WALL HUNG WATER CLOSET TO BE REMOVED COMPLETELY INCLUDING FLUSH VALVE. CAP ALL PIPING WATER TIGHT AS REQUIRED.
- EXISTING WALL MOUNTED WATER CLOSET TO BE REMOVED COMPLETELY INCLUDING FLUSH VALVE AND CHAIR CARRIER. EXISTING SUPPLY, WASTE, AND VENT PIPING TO BE REUSED FOR NEW FIXTURE AT NEW HEIGHT AND SLIGHTLY DIFFERENT LOCATION TO MEET ADA.
- EXISTING WALL HUNG URINAL TO BE REMOVED COMPLETELY INCLUDING FLUSH VALVE AND CHAIR CARRIER. EXISTING SUPPLY, WASTE, AND VENT PIPING TO BE REUSED FOR NEW FIXTURE AT NEW HEIGHT AND SLIGHTLY DIFFERENT LOCATION TO MEET ADA.
- (12) EXISTING 21" COLD WATER AND 1" HOT WATER VALVES TO BE REMOVED AND REPLACED.
- EXISTING ELECTRIC WATER COOLER TO BE REMOVED COMPLETELY. EXISTING SUPPLY, WASTE, AND VENT PIPING TO BE REUSED FOR NEW FIXTURE.



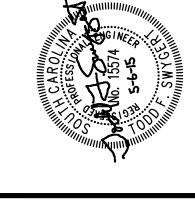

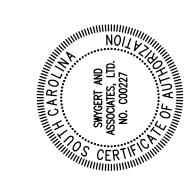

BATHROOM

REVISIONS NO. DATE DESCRIPTION

PROJECT NUMBER

Swygert & Associates


PD101

SHEET NUMBER


**DEMOLITION FLOOR PLANS** 

CONSULTING ENGINEERS DATE 08/07/2015

LIGHTING FIXTURE SCHEDULE									
SYMBOL	TYPE	DESCRIPTION	MANUFACTURER	MODEL NUMBER	OPTICAL ELEMENT	MOUNTING	VOLTS	LAMPS (PHILIPS)	
·	AF	2'x2' L.E.D. FIXTURE FOR INSTALLATION IN A GYPSUM CEILING (FLANGED OPTION)	WILLIAMS	LPT-22-L30-840-AF12125-DRV with DFK 2x2 FLANGE KIT	0.125" ACRYLIC LENS	CEILING RECESSED	120/277V UNIVERS.	L.E.D 3000 lumens, 4000K	
•	AG	2'x2' L.E.D. TROFFER FOR INSTALLATION IN A GRID CEILING.	WILLIAMS	LPT-22-L30-840-AF12125-DRV	0.125" ACRYLIC LENS	CEILING GRID RECESSED	120/277V UNIVERS.	L.E.D 3000 lumens, 4000K	
•	AS	2'x2' L.E.D. FIXTURE FOR SURFACE MOUNTING ON A GYPSUM CEILING (MODULAR)	WILLIAMS	12-2-L43-840-AF12125-DRV	0.125" ACRYLIC LENS	CEILING SURFACE	120/277V UNIVERS.	L.E.D 3000 lumens, 4000K	
•	BG	2'x4' L.E.D. TROFFER FOR INSTALLATION IN A GRID CEILING.	WILLIAMS	LPT-24-L42-840-AF12125-DVR	0.125" ACRYLIC LENS	CEILING GRID RECESSED	120/277 UNIVERS.	L.E.D 4300 lumens, 4000K	
•	BS	2'x4' L.E.D. FIXTURE FOR SURFACE MOUNTING ON A GYPSUM CEILING (MODULAR)	WILLIAMS	12-4-L84-840-S-AF12125-DRV	0.125" ACRYLIC LENS	CEILING SURFACE	120/277 UNIVERS.	L.E.D 4300 lumens, 4000K	
•	CS	1'x4' L.E.D. FIXTURE FOR SURFACE MOUNTING ON A GYPSUM CEILING (MODULAR)	WILLIAMS	11-4-L52-840-S-AF12125-DRV	0.125" ACRYLIC LENS	CEILING SURFACE	120/277 UNIVERS.	L.E.D 5200 lumens, 4000k	
<u>.</u>	DS	4' L.E.D. TYPE VANITY WALL FIXTURE WITH UP AND DOWN LIGHT.	WILLIAMS	WMA-4-LED-PH65-840-AF-EPPPH	0.125" ACRYLIC LENS	SURFACE WALL MOUNT	120/277 UNIVERS.	L.E.D 6500 lumens, 4000k	
<b>4</b>	U1	EMERGENCY LIGHTING UNIT, WALL MOUNTED WITH TWO HEADS, SELF DIAGNOSTICS, AND A 90 MINUTE BATTERY BACKUP SYSTEM.	EMERGI-LITE	PRO-3N-LA-AD	MR16 HEADLAMPS (FLOOD)	MOUNT OVER EXISTING BOX.	120/277V UNIVERS.	2 - 6-VOLT, 4-WATT MR16 L.E.D.	

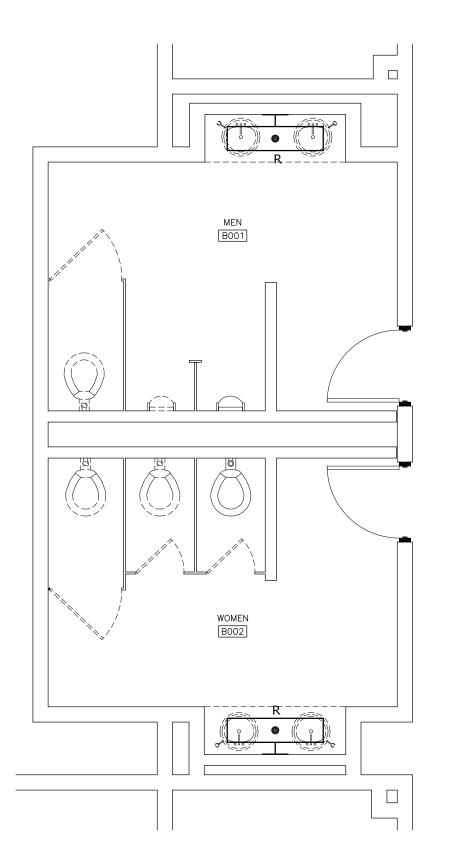



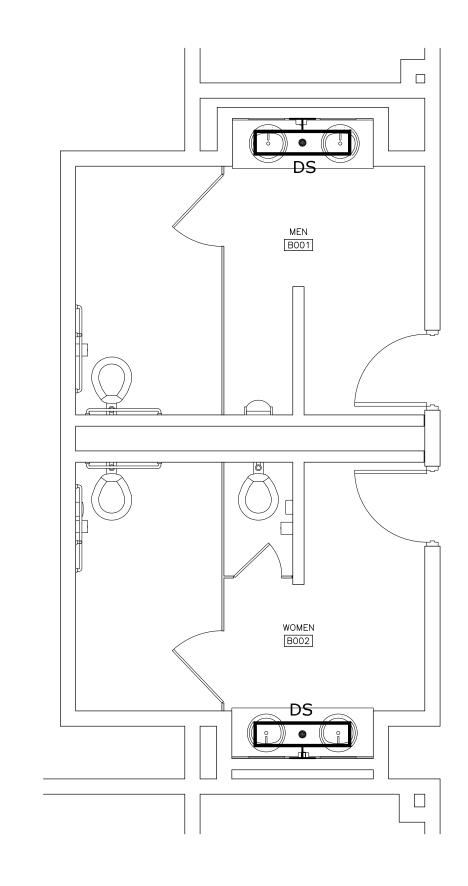

BASEMENT TOILET ELECTRICAL RENOVATION SCALE: 1/4" = 1'-0" BASE BID

# GENERAL CONSTRUCTION NOTES

1. PROVIDE ALL WORK IN ACCORDANCE WITH THE FOLLOWING CODES AND STANDARDS:

INTERNATIONAL BUILDING CODE 2012 EDITION NFPA 70 - NATIONAL ELECTRICAL CODE 2011 EDITION

ANSI A117.1 - ACCESSIBLE AND USABLE 2009 EDITION BUILDINGS AND FACILITIES

2. PROVIDE RACEWAY AND WIRING TO ALL DEVICES, FIXTURES, AND EQUIPMENT INDICATED ON THE CONTRACT DRAWINGS. THE DRAWINGS INDICATE PARTIAL RACEWAY AND WIRING REQUIREMENTS TO HELP CLARIFY DESIGN INTENT. WHERE RACEWAY AND/OR WIRING IS NOT INDICATED FOR DEVICES, FIXTURES, OR

EQUIPMENT THE ARRANGEMENT, GROUPING, AND ROUTING SHALL BE PROVIDED IN ACCORDANCE WITH THE 2011 EDITION OF THE NATIONAL ELECTRICAL CODE. CONTRACTOR MAY ONLY RE-USE EXISTING RACEWAYS AND WIRING WHERE THEIR CURRENT INSTALLATION METHODS COMPLY WITH THE 2011 EDITION OF THE NATIONAL ELECTRICAL CODE (CONTRACTOR MAY CORRECT DEFICIENT INSTALLATION METHODS IF PRACTICAL IN LIEU OF PROVIDING NEW RACEWAYS AND WIRING).

- 3. ALL CONDUIT PENETRATIONS THROUGH WALLS AND CEILINGS SHALL BE 2-HOUR FIRESTOPPED - HILTI OR EQUAL.
- 4. RACEWAYS SHALL BE 3/4" EMT WITH COMPRESSION TYPE FITTINGS UNLESS NOTED OR DETAILED OTHERWISE. PROVIDE FIXTURE WHIPS THAT COMPLY WITH THE NATIONAL ELECTRICAL CODE.
- 5. JUNCTION BOXES SHALL BE STEEL TYPE WITH SCREW COVER, SIZED AND SUPPORTED IN ACCORDANCE WITH THE NATIONAL ELECTRICAL CODE. PROVIDE JUNCTION BOXES AS REQUIRED FOR POWER AND CONTROL WIRING RENOVATIONS.
- 6. INSTALL ELECTRICAL SYSTEMS WITHOUT INTERFERING WITH DUCTS, PIPES, STRUCTURAL MEMBERS, OR OTHER SYSTEMS.
- PROVIDE SEISMIC WIRE SUPPORTS FOR ALL NEW LIGHTING FIXTURES. FIXTURES SHALL BE SUPPORTED WITH TWO WIRES. PROVIDE U.L. LISTED FIXTURE GRID CLIPS AT OR NEAR EACH FIXTURE CORNER.
- 3. THOROUGHLY CLEAN ALL EQUIPMENT AND SYSTEMS BEFORE PLACING IN OPERATION. RESTORE FINISHED SURFACES IF DAMAGED AND DELIVER THE ENTIRE INSTALLATION IN AN APPROVED CONDITION. THE CONTRACTOR SHALL INSTRUCT THE OWNER'S PERSONNEL IN THE PROPER OPERATION AND MAINTENANCE OF ALL SYSTEMS. FURNISH 3 SETS OF OPERATION AND MAINTENANCE MANUALS TO THE OWNER FOR EACH SYSTEM.
- 9. THE CONTRACTOR SHALL GUARANTEE THE WORK INSTALLED UNDER THIS CONTRACT FOR A PERIOD OF ONE YEAR AFTER DATE OF FINAL ACCEPTANCE. DEFECTS WHICH APPEAR AS A RESULT OF NORMAL USAGE SHALL BE REMEDIED BY THE CONTRACTOR TO THE COMPLETE SATISFACTION OF THE OWNER WITHOUT COST TO THE OWNER.
- 10. CUTTING, DRILLING, AND PATCHING: PROVIDE CHASES, SLOTS, AND OPENINGS IN EXISTING BUILDING COMPONENTS TO ALLOW FOR ELECTRICAL INSTALLATIONS. PERFORM CUTTING, DRILLING, FITTING, AND PATCHING REQUIRED TO:
- A) INSTALL EQUIPMENT, MATERIALS, AND RACEWAYS IN EXISTING STRUCTURES.
- B) REMOVE AND REPLACE DEFECTIVE WORK THAT DOES NOT CONFORM TO REQUIREMENTS OF THE CONTRACT DOCUMENTS.
- C) UPON WRITTEN INSTRUCTIONS FROM THE ARCHITECT/ENGINEER, UNCOVER AND RESTORE WORK TO PROVIDE FOR ARCHITECT/ENGINEER OBSERVATION OF

PROTECT EXISTING STRUCTURES, FURNISHINGS, FINISHES, MECHANICAL SYSTEMS, AND ELECTRICAL SYSTEMS WHILE PERFORMING CUTTING, DRILLING, FITTING, AND PATCHING.

PATCH EXISTING SURFACES AND BUILDING COMPONENTS USING NEW MATERIALS THAT MATCH EXISTING MATERIALS. PATCHING SHALL BE PERFORMED BY EXPERIENCED INSTALLERS.

ELECTRICAL LEGEND										
SYMBOL	DESCRIPTION									
A • 14	LIGHTING FIXTURE; TYPE AND CIRCUIT NUMBER AS INDICATED. SEE THE LIGHTING FIXTURE SCHEDULE FOR ADDITIONAL SYMBOLS AND TYPES.									
\$	SINGLE-POLE TOGGLE SWITCH RATED 277 VOLTS, 20 AMPS. FLUSH MOUNT SWITCH ON WALL AT 42 INCHES AFF UNLESS NOTED OTHERWISE; MOUNT IN EXISTING BACKBOX WHERE APPLICABLE. PROVIDE A BRUSHED ALUMINUM WALLPLATE FOR SWITCH.									
GFI <b>—</b>	DUPLEX, GROUND-FAULT-INTERRUPT TYPE RECEPTACLE, NEMA 5-20R. FLUSH MOUNT DEVICE IN WALL AT 18" AFF UNLESS NOTED OTHERWISE; MOUNT IN EXISTING BACKBOX WHERE APPLICABLE.									
	EXISTING ONE-SECTION PANELBOARD, SURFACE MOUNTED - TO REMAIN IN PLACE.									
• R	EXISTING 2'x2' FLUORESCENT LIGHTING FIXTURE - REMOVE.									
• R	EXISTING 2'x4' FLUORESCENT LIGHTING FIXTURE - REMOVE.									
P R	EXISTING 4' VANITY FLUORESCENT WALL FIXTURE - REMOVE.									
<b>4≟</b> R	EXISTING WALL MOUNTED EMERGENCY LIGHTING UNIT - REMOVE.									

# GENERAL DEMOLITION NOTES

REMAIN IN PLACE UNLESS NOTED OTHERWISE ON PLAN.

EXISTING SINGLE-POLE LIGHT SWITCH - REMOVE SWITCH; BACKBOX TO

- REMOVE AND LEGALLY DISPOSE OF ALL EXISTING LIGHTING FIXTURES, EMERGENCY LIGHTING UNITS, AND ASSOCIATED BALLSTS AND LAMPS.
- THE CONTRACTOR SHALL VISIT THE SITE/BUILDING TO FIELD VERIFY EXISTING CONDITIONS PRIOR TO BID AND SHALL INCLUDE ALL WORK REQUIRED FOR COMPLETE DEMOLITION IN HIS BID - SEE GENERAL CONSTRUCTION NOTE 2 ON THIS DRAWING.

		_
FLECTRICAL	DRAWING INDEX	

GENERAL NOTES, LEGEND, SCHEDULES, AND PLANS E101 FIRST FLOOR ELECTRICAL PLANS

SECOND FLOOR ELECTRICAL PLANS THIRD FLOOR ELECTRICAL PLANS

E102

E103

NO. DATE | DESCRIPTION

STATE PROJECT NUMBER: H27-61060

PROJECT NUMBER

SHEET NUMBER E100

**GENERAL NOTES, LEGEND & SCHEDULES** 


DATE **08/07/2015** 

(803) 528-1437 Joe.Land.LEA@sc.rr.com

SLR-2015-01

262 SANDHURST ROAD, SUITE 101 COLUMBIA, SOUTH CAROLINA


- 1. ALL LIGHTING CIRCUITS SHALL BE TWO #12 AWG THHN WITH ONE #12 AWG GREEN INSULATED GROUND WIRE IN 3/4" EMT RACEWAY UNLESS NOTED OTHERWISE.
- 2. VERIFY BY TURNING OFF CIRCUIT BREAKER THAT SERVES LIGHTING FIXTURES IN RESTROOMS THAT THE EMERGENCY LIGHTING UNIT IN EACH RESTROOM WILL BE PROPERLY ACTIVATED. NOTIFY ARCHITECT/ENGINEER IF OTHERWISE.

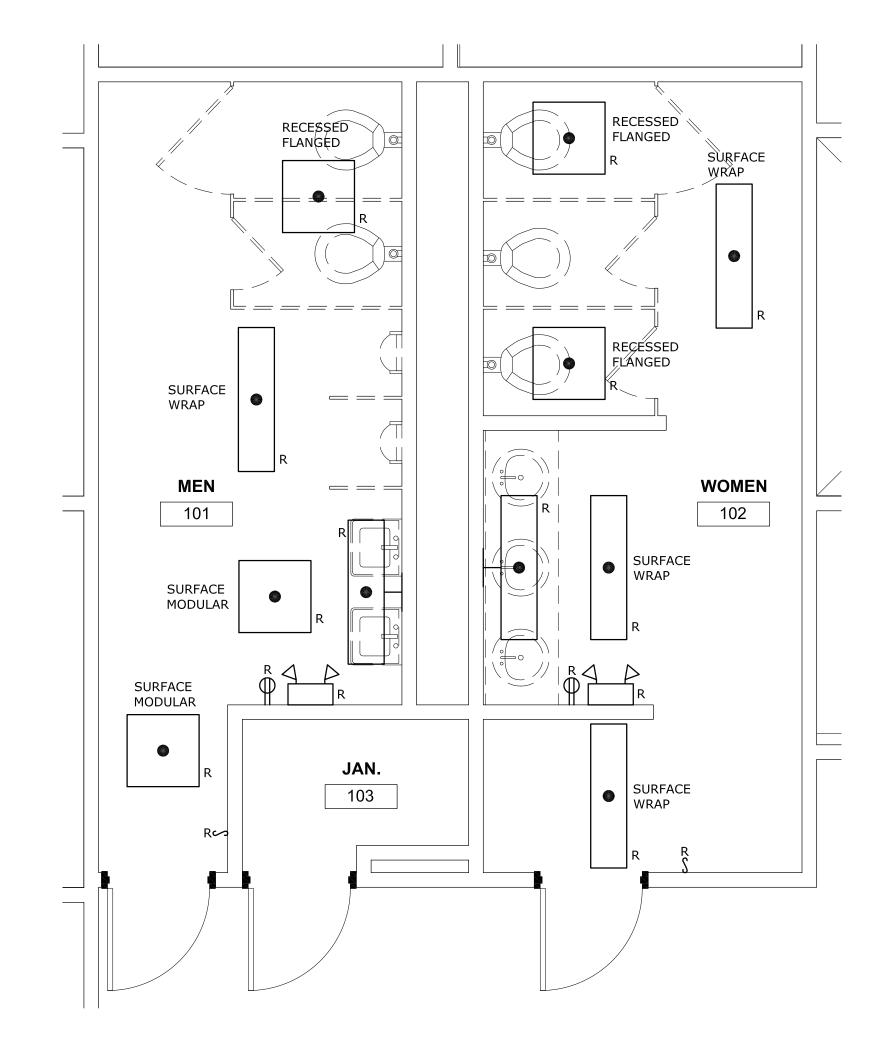

1st FLOOR TOILET ELECTRICAL DEMOLITION

SCALE: 3/8" = 1'-0"


BASE BID

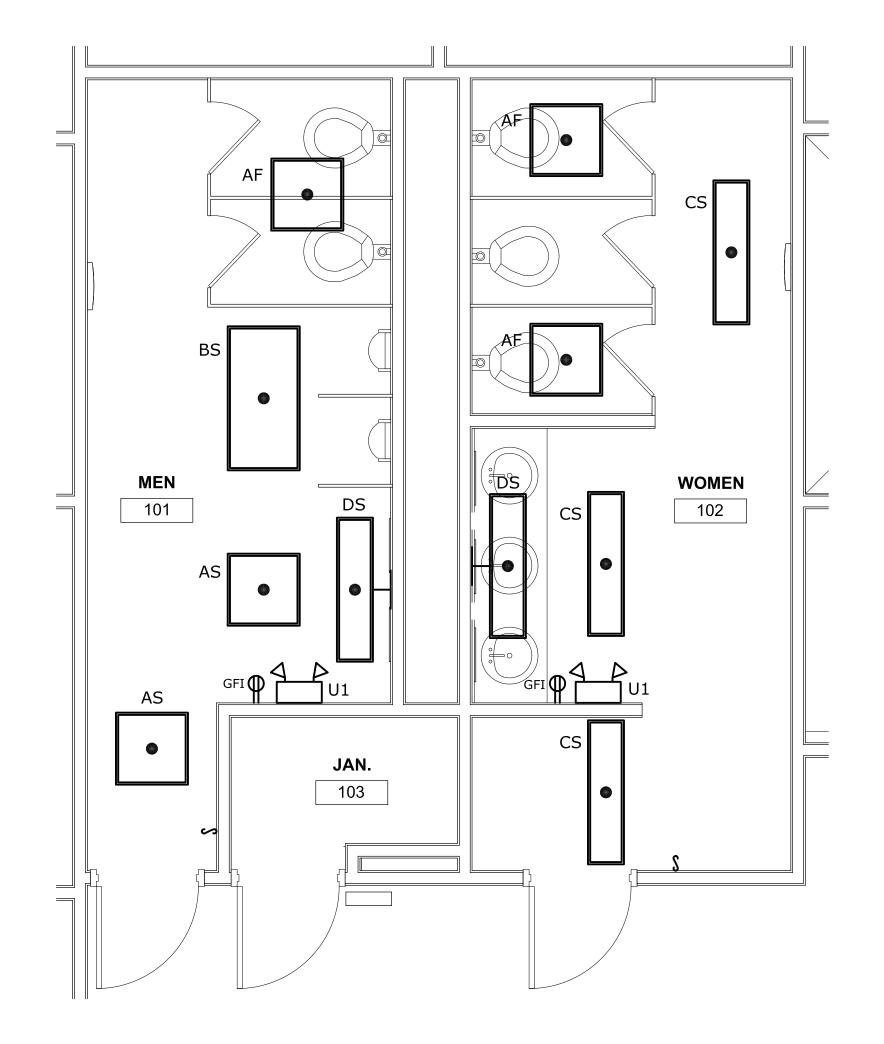

1st FLOOR TOILET ELECTRICAL RENOVATION

SCALE: 3/8" = 1'-0"

BASE BID

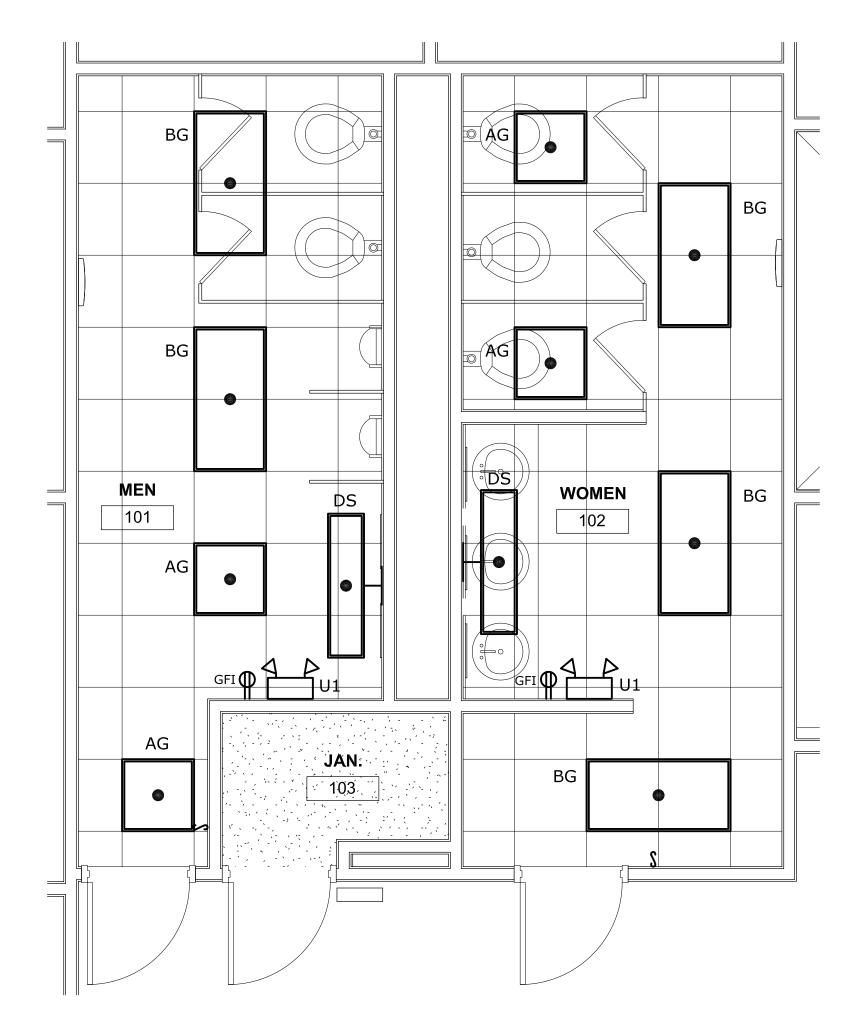

1st FLOOR TOILET ELECTRICAL RENOVATION

SCALE: 3/8" = 1'-0"

ADD ALTERNATE 1

# 17/20/80 - STNEMISCO GE

NO. DATE DESCRIPTION

STATE PROJECT NUMBER: H27-61060

INTERIORS

ARCHITEC

PROJECT NUMBER

SHEET NUMBER

E101


SHEET NAME
FIRST FLOOR
ELECTRICAL PLANS

DATE 08/07/2015




262 SANDHURST ROAD, SUITE 101
COLUMBIA, SOUTH CAROLINA
(803) 528-1437

- 1. ALL LIGHTING CIRCUITS SHALL BE TWO #12 AWG THHN WITH ONE #12 AWG GREEN INSULATED GROUND WIRE IN 3/4" EMT RACEWAY UNLESS NOTED OTHERWISE.
- . VERIFY BY TURNING OFF CIRCUIT BREAKER THAT SERVES LIGHTING FIXTURES IN RESTROOMS THAT THE EMERGENCY LIGHTING UNIT IN EACH RESTROOM WILL BE PROPERLY ACTIVATED. NOTIFY ARCHITECT/ ENGINEER IF OTHERWISE.
- . LIGHT SWITCHES, RECEPTACLES, AND EMERGENCY LIGHTING UNITS REFERENCED TO THIS NOTE SHALL BE RELOCATED TO ACCOMMODATE WALL RENOVATIONS. RELOCATE AND/OR EXTEND EXISTING RACEWAYS AND WIRING AS REQUIRED TO SERVE DEVICES AND EMERGENCY LIGHTING UNITS AT NEW LOCATIONS.

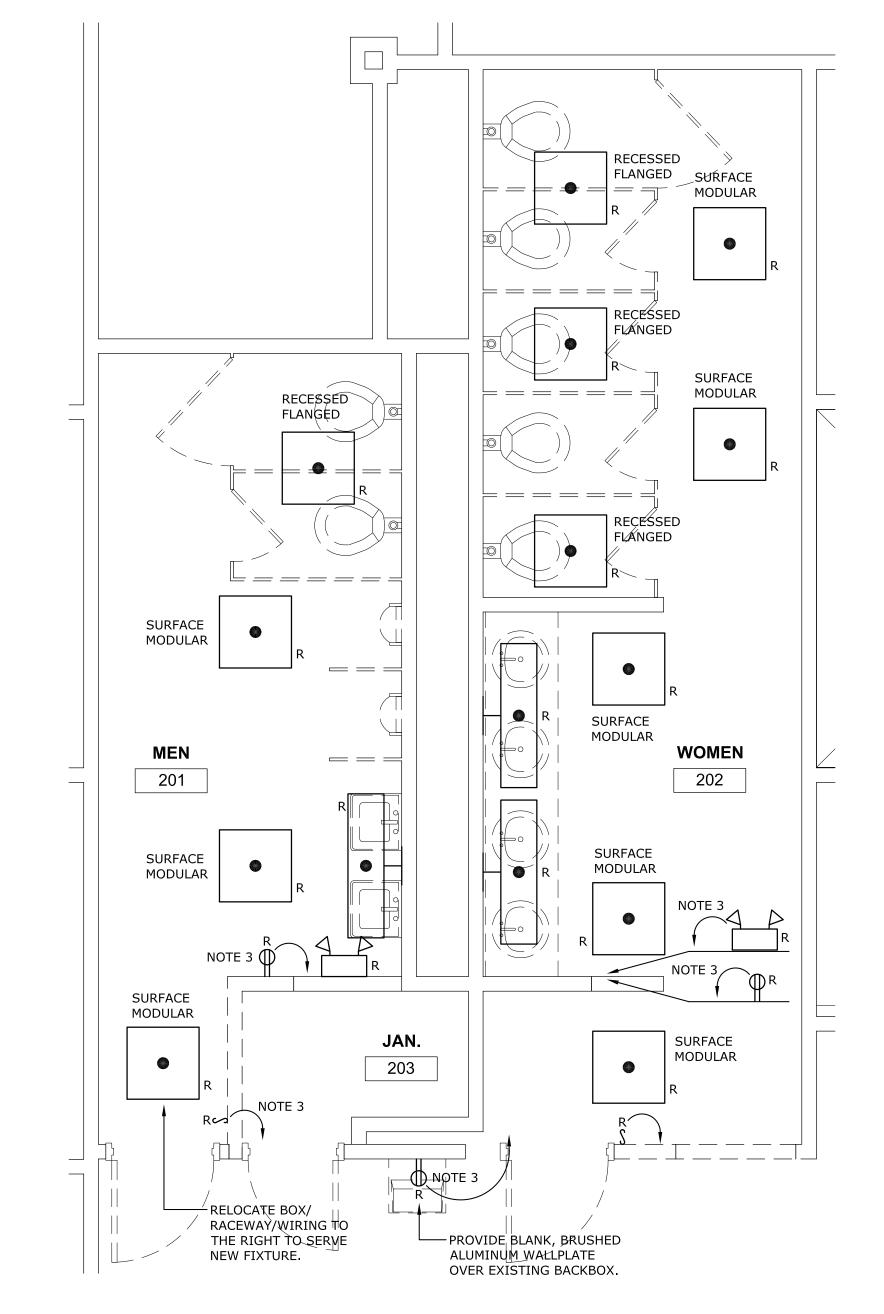


2nd FLOOR TOILET ELECTRICAL DEMOLITION

SCALE: 3/8" = 1'-0" BASE BID

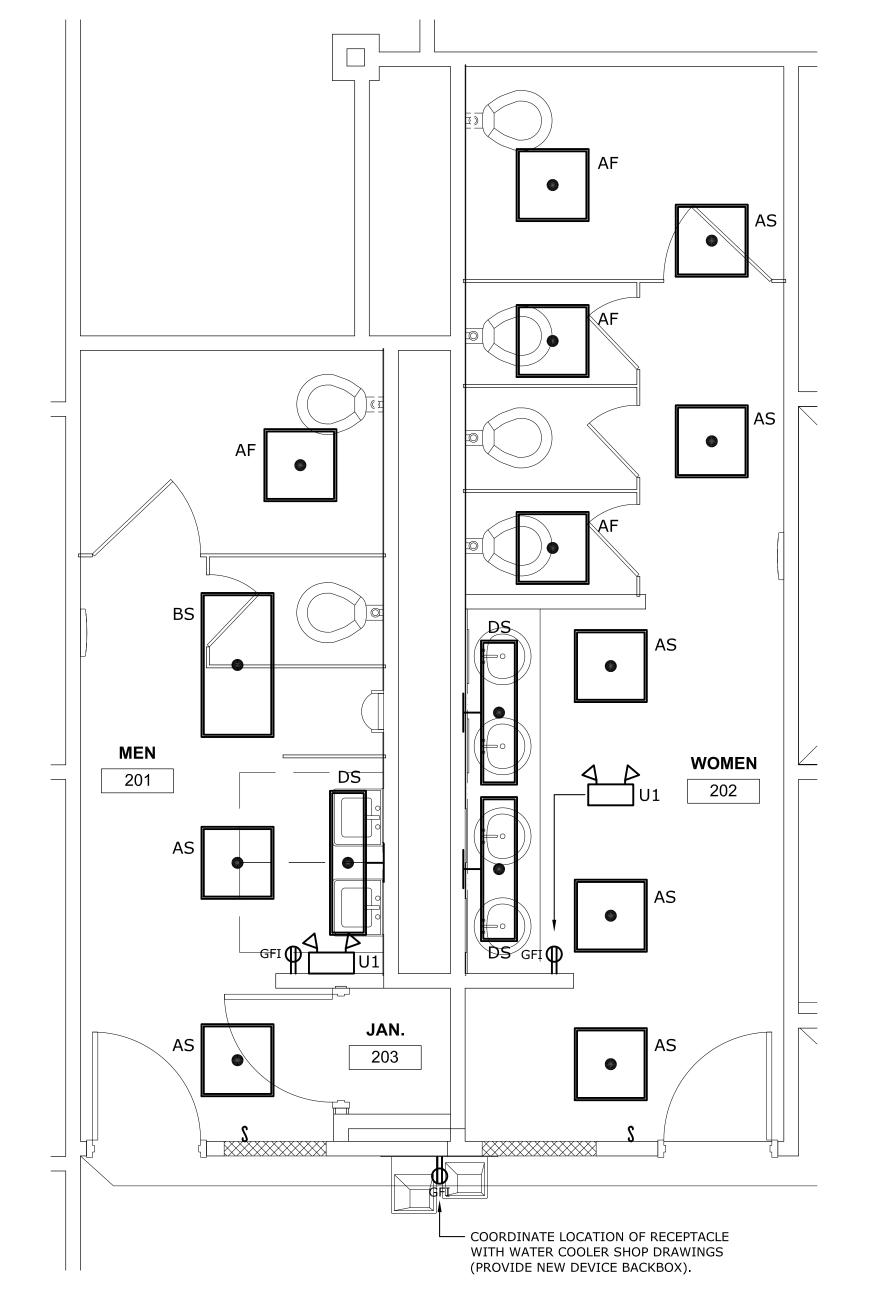


2nd FLOOR TOILET ELECTRICAL RENOVATION

SCALE: 3/8" = 1'-0" BASE BID

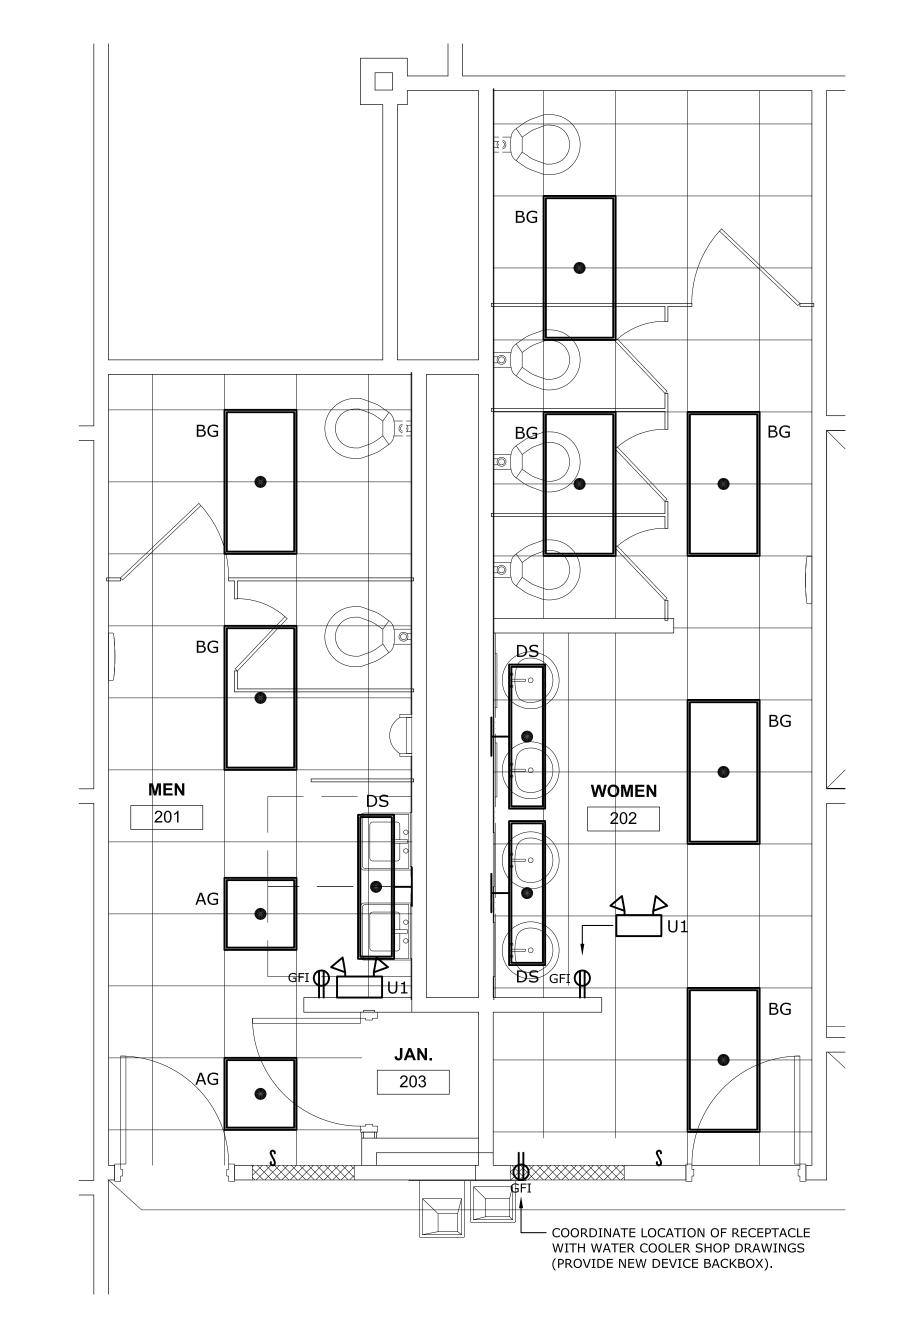

2nd FLOOR TOILET ELECTRICAL RENOVATION

SCALE: 3/8" = 1'-0" ADD ALTERNATE 1

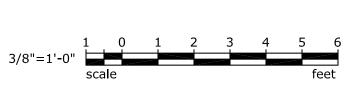



262 SANDHURST ROAD, SUITE 101 COLUMBIA, SOUTH CAROLINA (803) 528-1437 Joe.Land.LEA@sc.rr.com

STATE PROJECT NUMBER: H27-61060 PROJECT NUMBER SLR-2015-01 SHEET NUMBER

E102

**REVISIONS** 


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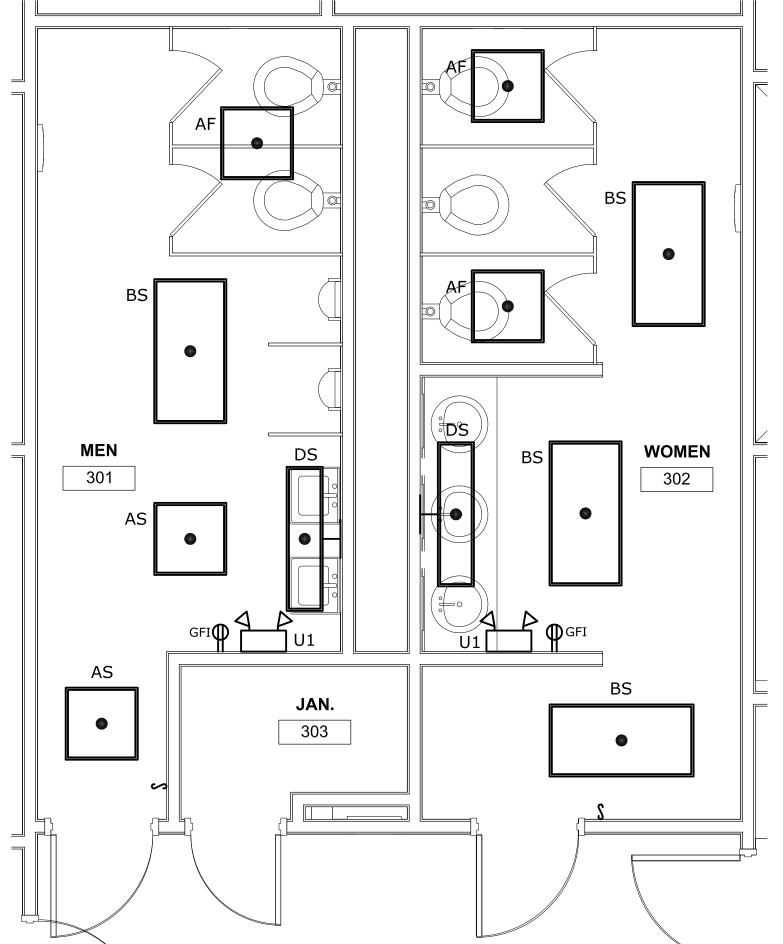
INTERIORS

ARCHITEC

SHEET NAME
SECOND FLOOR
ELECTRICAL PLANS DATE **08/07/2015** 


. VERIFY BY TURNING OFF CIRCUIT BREAKER THAT SERVES LIGHTING FIXTURES IN RESTROOMS THAT THE EMERGENCY LIGHTING UNIT IN EACH RESTROOM WILL BE PROPERLY ACTIVATED. NOTIFY ARCHITECT/ ENGINEER IF OTHERWISE.



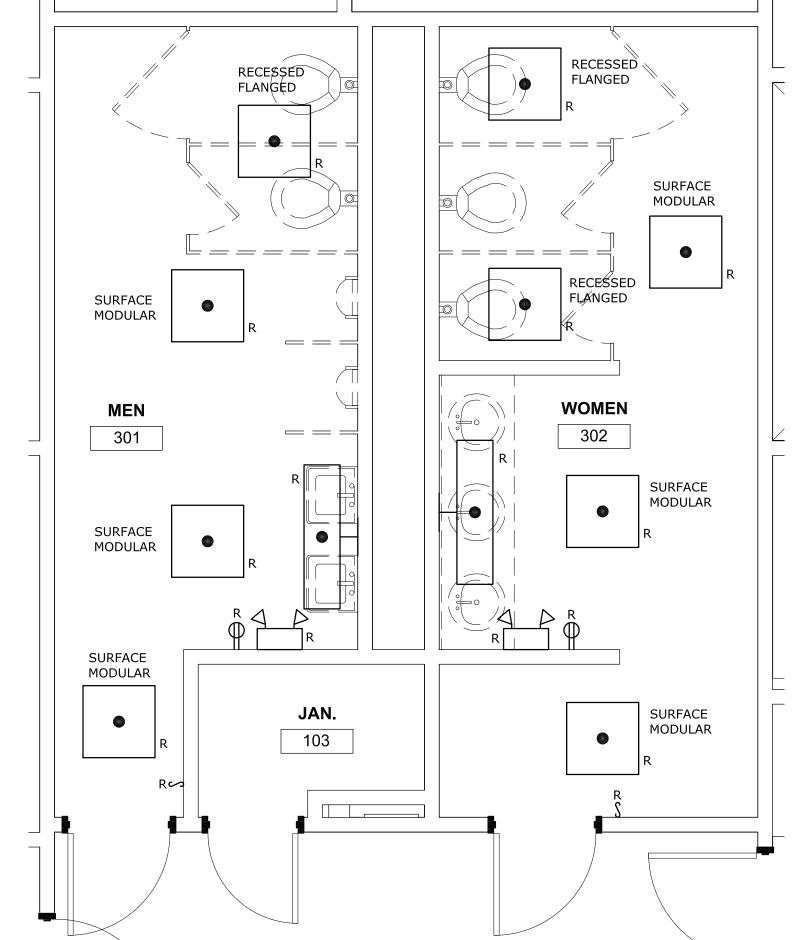

3rd FLOOR TOILET ELECTRICAL RENOVATION

SCALE: 3/8" = 1'-0" BASE BID

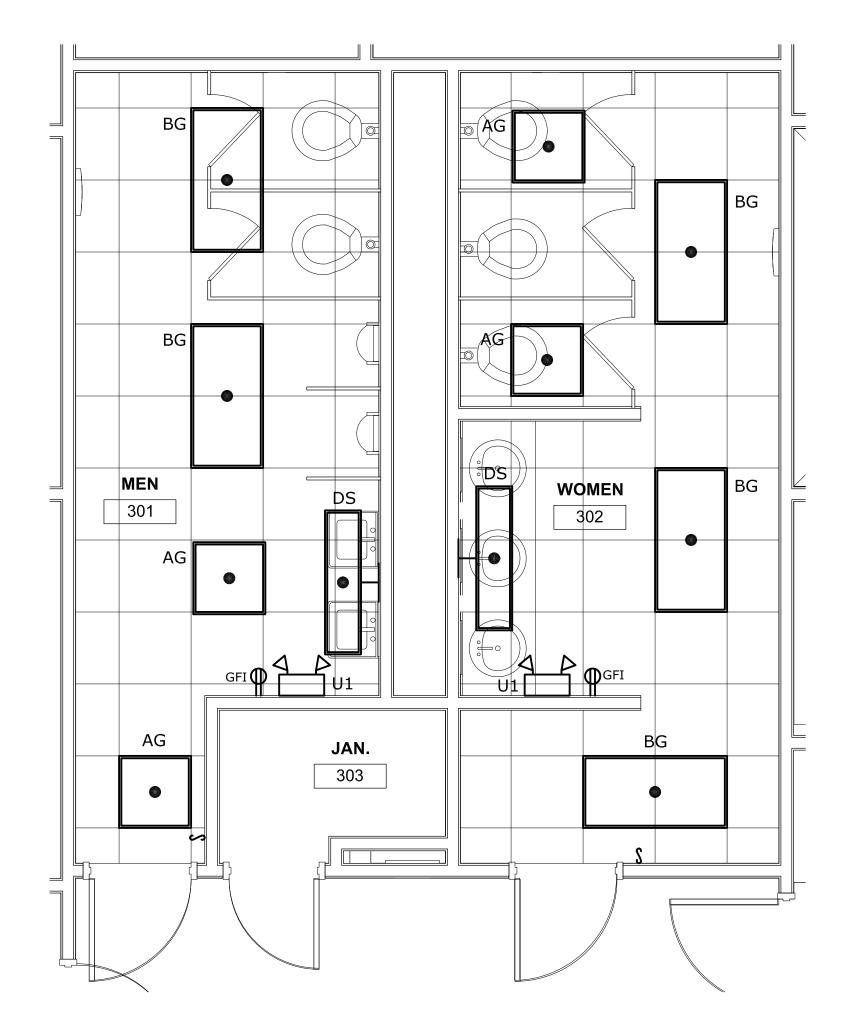

3 3rd FLOOR TOILET ELECTRICAL RENOVATION

SCALE: 3/8" = 1'-0"

ADD ALTERNATE 1 ADD ALTERNATE 1

STATE PROJECT NUMBER: H27-61060

**REVISIONS** 

NO. DATE DESCRIPTION

INTERIORS

ARCHITEC

PROJECT NUMBER SHEET NUMBER E103

SHEET NAME
THIRD FLOOR
ELECTRICAL PLANS

DATE **08/07/2015** 



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3rd FLOOR TOILET ELECTRICAL DEMOLITION

SCALE: 3/8" = 1'-0" BASE BID